

DESIGN & CONSTRUCTION GROUP THE GOVERNOR NELSON A. ROCKEFELLER EMPIRE STATE PLAZA ALBANY, NY 12242

ADDENDUM NO. 1 TO PROJECT NO. 44894

ELECTRICAL WORK PROVIDE FIRE DETECTION SYSTEM SWAN STREET BUILDING ALBANY, NY 12242

April 2, 2024

NOTE: This Addendum forms a part of the Contract Documents. Insert it in the Project Manual. Acknowledge receipt of this Addendum in the space provided on the Bid Form.

- 1. Revised Drawings:
 - a. Drawing Nos. G-002, FA-106, FA-107, FA-108, FA-109, FA-114, FA-115, FA-116, FA-117, FA-118, and FA-129, noted "Addendum #1 3/27/2024" accompany this Addendum and supersede the same numbered originally issued drawings.

END OF ADDENDUM

Brady Sherlock, P.E. Director, Division of Design Design & Construction

GENERAL NOTES:

- THE SCOPE OF THIS PROJECT INCLUDES PROVIDING A COMPLETELY SUPERVISED, INTELLIGENT, ANALOG, HONEYWELL ADDRESSABLE IN-BUILDING FIRE ALARM SYSTEM AND NETWORK ARCHITECTURE AS SHOWN ON THE DRAWINGS AND DESCRIBED WITHIN THE ACCOMPANYING SPECIFICATIONS. THE SYSTEMS SHALL INCLUDE ALL WIRING, RACEWAYS, PULL BOXES, TERMINAL CABINETS, OUTLET AND MOUNTING BOXES, CONTROL EQUIPMENT, ALARM AND SUPERVISORY SIGNALS, INITIATING DEVICES, NOTIFICATION APPLIANCES, NOTIFICATION ALARM PANELS, INTERFACE EQUIPMENT, AND ALL OTHER ACCESSORIES AND MISCELLANEOUS ITEMS INCLUDING SOFTWARE, SYSTEM PROGRAMMING AND TESTING REQUIRED FOR A COMPLETE OPERATING SYSTEM EVEN THOUGH EACH ITEM IS NOT SPECIFICALLY MENTIONED OR DESCRIBED. WORK INCLUDES INTERFACING EXISTING FIRE ALARM EQUIPMENT TO PROVIDE UNINTERRUPTED ALARM, DETECTION, AND NOTIFICATION THROUGHOUT THE OCCUPIED BUILDING. FOLLOWING ACCEPTANCE OF THE PROVIDED FIRE ALARM SYSTEM, THE EXISTING SYSTEM SHALL BE DISCONNECTED AND REMOVED. INCLUDE IN BID ALL COSTS ASSOCIATED WITH REMOVAL AND 21. EXISTING EQUIPMENT & DEVICES ARE SHOWN FOR REFERENCE ONLY. VERIFY EXISTING CONDITIONS AND BRING REPLACEMENT OF FIRE ALARM SYSTEM WORK AS DESCRIBED IN THE DRAWINGS AND SPECIFICATIONS.
- EXISTING DEVICES AND EQUIPMENT SHOWN ARE REPRESENTATIVE ONLY. NOT ALL EXISTING DEVICES AND EQUIPMENT INDICATED.
- COMPLY WITH THE FOLLOWING CODES AND STANDARDS:
- 3.1. NFPA 70 NATIONAL ELECTRICAL CODE, 2017 EDITION
- 3.2. NFPA 72 NATIONAL FIRE ALARM AND SIGNALING CODE, 2016 EDITION
- 3.3. NFPA 13 INSTALLATION OF SPRINKLER SYSTEMS, 2016 EDITION
- 3.4. NFPA 20 INSTALLATION OF STATIONARY PUMPS FOR FIRE PROTECTION, 2016 EDITION
- 3.5. 2020 BUILDING CODE OF NEW YORK STATE 3.6. 2020 FIRE CODE OF NEW YORK STATE
- THE FIRE ALARM SYSTEM MUST COMPLY WITH THE ADOPTED CODES AND STANDARDS INCLUDING ALL ANNEXES/APPENDICES AT THE TIME FIRE ALARM WORK IS PERMITTED. THE EQUIPMENT PROVIDED BY SHALL BE 24. LISTED FOR THE INTENDED PURPOSE BY A NATIONALLY RECOGNIZED TESTING LABORATORY.
- PROVIDE INSPECTIONS AND FINAL SYSTEM ACCEPTANCE AS REQUIRED.
- COORDINATE ALL DRAWINGS AND SPECIFICATIONS PRIOR TO COMMENCING WORK. QUESTIONS REGARDING DESIGN INTENT OR SYSTEM OPERATION SHALL BE PROMPTLY BROUGHT TO THE ATTENTION OF THE DIRECTOR'S REPRESENTATIVE.
- FIELD VERIFY AND COORDINATE ALL EXISTING CONDITIONS AND DIMENSIONS INDICATED ON DRAWINGS PRIOR TO EXECUTION OF THIS CONTRACT.
- AVOID ALL CONFLICTS WITH EXISTING LIGHT FIXTURES, HVAC DIFFUSERS, GRILLES, DUCTS, CONDUIT AND OTHER PIPING OR OTHER OBSTRUCTIONS ENCOUNTERED. COORDINATE ALL WORK WITH EXISTING FIELD CONDITIONS. PROMPTLY NOTIFY THE DIRECTOR'S REPRESENTATIVE PRIOR TO INITIATING WORK IF ANY MOUNTING LOCATIONS ARE OBSTRUCTED AND/OR IF ANY MOUNTING CONFLICTS OR PROBLEMS ARE DISCOVERED.
- ANY CONFLICTS BETWEEN SPECIFICATIONS AND DRAWINGS SHALL BE BROUGHT TO THE DIRECTOR'S REPRESENTATIVE ATTENTION IMMEDIATELY. DO NOT PROCEED WITH ANY WORK EXCEPT AT OWN RISK, UNTIL CLARIFICATIONS OF CONFLICTS ARE ISSUED BY THE DIRECTOR'S REPRESENTATIVE.
- 10. EXTREME CARE SHALL BE EXERCISED WHEN ROUGHING IN DEVICES SO AS NOT TO DAMAGE THE EXISTING BUILDING FINISHES.
- 11. MOUNT ALL VISUAL WARNING STROBE NOTIFICATION APPLIANCES TO ACHIEVE MAXIMUM VISIBILITY IN ACCORDANCE WITH CURRENT NFPA 72 GUIDELINES.
- 11.1. WALL-MOUNTED APPLIANCES SHALL BE MOUNTED SUCH THAT THE ENTIRE LENS IS NOT LESS THAN 80 IN. AND NOT GREATER THAN 96 IN. ABOVE THE FINISHED FLOOR OR AT THE MOUNTING HEIGHT SPECIFIED USING THE PERFORMANCE-BASED ALTERNATIVE OF NFPA 72, 2016 EDITION SECTION 18.5.5.6. WHERE LOW CEILING HEIGHTS DO NOT PERMIT WALL MOUNTING AT A MINIMUM OF 80 IN., WALL 12. IN AREAS MOUNTED VISIBLE APPLIANCES SHALL BE MOUNTED WITHIN 6 IN. OF THE CEILING. THE ROOM SIZE COVERED BY A STROBE OF A GIVEN VALUE SHALL BE REDUCED BY TWICE THE DIFFERENCE BETWEEN THE MINIMUM MOUNTING HEIGHT OF 80 IN. AND THE ACTUAL LOWER MOUNTING HEIGHT.
- 11.2. VISIBLE APPLIANCES LISTED FOR MOUNTING PARALLEL TO THE FLOOR SHALL BE PERMITTED TO BE LOCATED ON THE CEILING OR SUSPENDED BELOW THE CEILING.
- 12. WITHOUT CEILINGS, RACEWAY SHALL BE INSTALLED AS UNOBTRUSIVELY AS POSSIBLE, AS CLOSE AS POSSIBLE TO FLOOR/ CEILING SLAB AND PARALLEL AND AT RIGHT ANGLES TO STRUCTURAL STEEL OR CONCRETE
- 13. AFTER RACEWAY INSTALLATION, PENETRATIONS IN FIRE RESISTIVE WALLS AND CEILINGS SHALL BE PROPERLY CLEANED AND SEALED TO THE FULL THICKNESS OF THE PENETRATION WITH A LISTED AND APPROVED FIRE STOPPING SYSTEM OF EQUAL OR GREATER FIRE RESISTANCE. UNLESS OTHERWISE NOTED, ALL FLOOR/CEILING SLABS, STAIR ENCLOSURES, VERTICAL SHAFT AND CHASE ENCLOSURES, MASONRY SLAB TO SLAB, MECHANICAL, ELECTRICAL AND FIRE ALARM CLOSET ROOM WALLS SHALL BE CONSIDERED 2 HOUR FIRE RESISTIVE RATED CONSTRUCTION, UNLESS OTHERWISE NOTED, AND FIRE STOPPED AS SPECIFIED. REFER TO DRAWINGS FOR EXISTING WALL FIRE RATINGS. PROVIDE UL LISTED THROUGH PENETRATION FIRESTOPPING ON ALL WALL AND FLOOR PENETRATIONS. FIRESTOPPING SHALL BE COMPATIBLE FOR WALL AND FLOOR CONSTRUCTION AS INDICATED. SUBMIT UL ASSEMBLY FOR APPROVAL PRIOR TO INSTALLATION.
- I. WIRING WITHIN ENCLOSURES: PROVIDE CONDUCTORS PARALLEL WITH OR AT RIGHT ANGLES TO SIDES AND BACK OF THE ENCLOSURE. BUNDLE, LACE, AND TRAIN CONDUCTORS TO TERMINAL POINTS WITH NO EXCESS. CONNECT CONDUCTORS THAT ARE TERMINATED, SPLICED, OR INTERRUPTED IN ANY ENCLOSURE ASSOCIATED WITH THE FIRE ALARM SYSTEM TO TERMINAL BLOCKS. MARK EACH TERMINAL ACCORDING TO THE SYSTEM'S WIRING DIAGRAMS. MAKE ALL CONNECTIONS WITH APPROVED CRIMP-ON TERMINAL SPADE LUGS, PRESSURE-TYPE TERMINAL BLOCKS, OR PLUG CONNECTORS. SPLICES UTILIZING A WIRE NUT ARE NOT ALLOWED. MACHINE LABEL EACH CONDUCTOR AND PROVIDE FIRE ALARM CIRCUIT IDENTIFICATION PER NEC
- 15. ALL DEVICES PROVIDED IN LAY-IN ACOUSTICAL TILE CEILINGS OR OTHER SUSPENDED TYPE CEILINGS SHALL BE INSTALLED CENTER OF TILE. PROVIDE STEEL HANGER RODS FROM THE BUILDING STRUCTURE TO SUPPORT DEVICES.
- 16. DRAWINGS ARE DIAGRAMMATIC IN NATURE AND INDICATE APPROXIMATE LOCATION OF DEVICES AND APPLIANCES. FIELD VERIFY THE LOCATION OF ALL DEVICES AND APPLIANCES WITH RESPECT TO EXISTING OBSTRUCTIONS IN ACCORDANCE WITH NFPA 72. PROVIDE ALL NECESSARY CONDUIT AND WIRE IN ACCORDANCE WITH THE APPLICABLE CODES, REGULATIONS, AND MANUFACTURER REQUIREMENTS.
- ALL EXISTING CONDITIONS SHOWN IN THESE PLANS WERE DOCUMENTED AT THE BEGINNING OF THIS PROJECT. ANY CHANGES TO THE EXISTING CONDITIONS AFTERWARDS ARE BEYOND THE CONTROL OF THE DESIGNER OF RECORD. FIELD VERIFY ALL EXISTING CONDITIONS PRIOR TO BEGINNING ANY WORK.

UNIFORM CODE COMPLIANCE STATEMENT

TO THE BEST KNOWLEDGE, BELIEF, AND PROFESSIONAL JUDGEMENT OF THE DESIGNERS-OF-RECORD, SUCH PLANS AND SPECIFICATIONS ARE IN COMPLIANCE WITH THE 2020 UNIFORM CODE OF NEW YORK

ENERGY CODE COMPLIANCE STATEMENT

STATE.

TO THE BEST KNOWLEDGE, BELIEF, AND PROFESSIONAL JUDGEMENT OF THE DESIGNERS-OF-RECORD, SUCH PLANS AND SPECIFICATIONS ARE IN COMPLIANCE WITH THE 2020 ENERGY CONSERVATION CODE OF NEW YORK STATE.

- 18. THE FACILITY WILL BE FULLY OPERATIONAL AND OCCUPIED DURING THE COURSE OF THIS PROJECT. REFER TO THE SPECIFICATIONS FOR WORKING HOUR RESTRICTIONS AND SECURITY REQUIREMENTS. COORDINATE AND SCHEDULE IN ADVANCE ALL WORK WITH THE DIRECTOR'S REPRESENTATIVE.
- 19. ALL MATERIALS SHALL BE GATHERED AT THE END OF THE DESIGNATED WORK HOURS FOR EACH AREA AND STORED WHERE DIRECTED BY THE DIRECTOR'S REPRESENTATIVE.
- 20. REMOVAL OF WORK SHALL BE PERFORMED IN A NEAT AND PROFESSIONAL MANNER. RESTORE, PATCH, PAINT, ETC. ANY INTERIOR/EXTERIOR BUILDING SURFACE TO CLOSELY MATCH THE SURROUNDING CONDITIONS. COORDINATE WITH THE DIRECTOR'S REPRESENTATIVE ON PAINT COLORS.
- ANY DISCREPANCIES TO THE DIRECTOR'S REPRESENTATIVE ATTENTION IN WRITING.
- 22. ALL FIRE ALARM REMOVAL WORK SHALL INCLUDE BUT NOT BE LIMITED TO THE DISCONNECTION, REMOVAL, AND DISPOSAL OF INITIATION AND NOTIFICATION DEVICES, JUNCTION BOXES, WIRE, CABLE, CONDUIT, MOUNTING HARDWARE STRAPS OR CABLES, INCLUDING EXISTING FIRE ALARM CONTROL PANELS AND OTHER SYSTEM COMPONENTS, ETC. PER THE SCOPE OF WORK FOR THIS PROJECT.
- 23. REMOVE ALL FIRE ALARM EQUIPMENT DEVICES, INCLUDING ASSOCIATED WIRING, CONDUITS, COVERS, BOXES, ETC., WHERE INDICATED ON THE PLANS. WHERE THE REMOVAL OF THESE ITEMS DISRUPTS EXISTING WIRING THAT IS TO REMAIN, PROVIDE IN THE CEILING SPACE JUNCTION BOXES AND OTHER DEVICES AND PROVIDE BYPASS NECESSARY TO MAKE CIRCUITS AFFECTED CONTINUOUS AND READY FOR OPERATION. OTHERWISE, WIRING SHALL BE REMOVED BACK TO THE NEAREST ELECTRICAL JUNCTION BOX THAT IS TO REMAIN OR TO THE SOURCE PANELBOARD. REMOVED FIRE ALARM CONTROL PANELS SHALL REMAIN PROPERTY OF THE STATE. TURNOVER TO DIRECTOR'S REPRESENTATIVE.
- FACILITY MUST BE AVAILABLE FOR NORMAL OPERATIONS BY 6AM EVERY WORK DAY. REMOVAL OF ITEMS THAT WILL CAUSE ANY TYPE OF TEMPORARY SHUTDOWN SHALL BE PERFORMED DURING OFF-PEAK HOURS. ALL SUCH OUTAGES SHALL BE SCHEDULED AND COORDINATED WITH THE DIRECTOR'S REPRESENTATIVE TO ENSURE ESSENTIAL SERVICES OR AREAS CAN BE MAINTAINED. PROVIDE FIRE WATCH AT ALL TIMES WHEN SYSTEM IS DISABLED DURING UNOCCUPIED PERIODS.
- 25. ALL EXISTING FIRE ALARM PANELS AND EXISTING NOTIFICATION APPLIANCE POWER EXTENDERS SHALL BE MAINTAINED AS WORKING PANELS THROUGHOUT CONSTRUCTION AND WILL CONTINUE TO MAINTAIN CIRCUITS FOR EXISTING DEVICES TO REMAIN. PROVIDE AS NECESSARY TEMPORARY FEEDS TO ANY DEVICES THAT MAY BE REQUIRED FOR UNINTERRUPTED USE. PROVIDE TEMPORARY CONNECTIONS FOR RELOCATED EQUIPMENT DURING CONSTRUCTION.
- 26. ENSURE THAT ANY DEVICES LOCATED OUTSIDE OF WORK AREA ARE NOT AFFECTED BY REMOVAL WIRING AND/OR CIRCUITING, WIRING/CONDUIT SHALL BE LEFT IN A SAFE CONDITION, LABELED FOR ITS USE, AND EXTENDED AS REQUIRED TO MAINTAIN CIRCUIT CONTINUITY, INCLUDING ALL APPLICABLE CONTROLS.
- 27. PORTIONS OF INITIATION AND NOTIFICATION LOOP RUNS THAT SHALL BE REMOVED OR ABANDONED AS A RESULT OF WORK, BUT WHICH ARE REQUIRED TO REMAIN ENERGIZED, SHALL BE REROUTED AT CONVENIENT LOCATIONS AND RECONNECTED. LOOP EXTENSIONS SHALL MATCH EXISTING WIRING SPECIFICATIONS IN ALL ASPECTS INCLUDING BUT NOT LIMITED TO CABLE TYPE, CONDUIT SIZES, ETC.
- 28. FOR EQUIPMENT AND SYSTEMS INTENDED TO REMAIN IN PLACE OR BE REUSED, PERFORM A FUNCTIONAL CHECK TO CONFIRM PROPER OPERATION PRIOR TO ANY REMOVAL WORK AND/OR CONNECTION TO EQUIPMENT.
- 29. THE TERM "REMOVE" SHALL MEAN DISCONNECTED AND REMOVED BACK TO SOURCE. STOP REMOVAL WHERE DAMAGE TO ADJACENT SURFACES OR AREAS WOULD OCCUR IF FURTHER REMOVAL OCCURRED. CUT CONDUIT OFF AND REMOVE ALL WIRING CONDUCTORS COMPLETELY. RESTORE INTEGRITY OF FIRE RESISTANCE OF FLOOR OR WALL BY FIRE STOPPING ANY REMAINING CONDUIT PASSING THROUGH WALL OR FLOOR. REMOVE CIRCUITS FROM "EXISTING TO REMAIN" CONVENTIONAL DEVICES, FIRE ALARM CONTROL PANELS, AND FIRE PUMP CONTROLLERS AS SHOWN AS "EXISTING" ON THE REMOVAL DRAWINGS.
- 30. PROVIDE FIRE ALARM WIRING AND CONDUIT TO EXISTING DOOR CONTROLLERS FROM FACP/TERMINAL CABINETS (TYP. FOR 15 CONTROLLERS). EACH RUN IS APPROXIMATELY A MAXIMUM OF 500' FROM THE FACP/TERMINAL CABINET. FINAL CONNECTIONS AND PROGRAMMING BY OTHERS.

NYS UNIFORM BUILDING CODE DATA

VENTILATION

ALL WORK MUST COMPLY WITH THE UNIFORM FIRE PREVENTION CODE OF NYS STATE OR THE "UNIFORM CODE". THE PUBLICATIONS INCORPORATED BY REFERENCE INCLUDE THE 2020 BUILDING CODE OF NEW YORK STATE, THE 2020 EXISTING BUILDING CODE OF NEW YORK STATE, THE 2020 PLUMBING CODE OF NEW YORK STATE, THE 2020 MECHANICAL CODE OF NEW YORK STATE, THE 2020 FUEL GAS CODE OF NEW YORK STATE, THE 2020 FIRE CODE OF NEW YORK STATE, THE 2020 PROPERTY MAINTENANCE CODE OF NEW YORK STATE.

BUILDING INFORMATION			ENERGY CONSERVATION		
OCCUPANCY GROUP USE OFFICES, PARKING GARAGES, AND MECHANICAL/ELECTRICAL ROOMS CONSTRUCTION TYPE IB MIXED OCCUPANCIES INCIDENTAL USE AREAS CONTROL AREAS *N/A* EXISTING BUILDING CODE COMPLIANCE METHOD CLASSIFICATION ALL ITEMS BELOW INDICATED WITH "N/A" ARE NOT REQUIRED TO BE MODIFIED OR UPGRADED TO MEET BCNYS 2020 CRITERIA PER THE WORK AREA COMPLIANCE METHOD, CHAPTERS 7 AND 8.			CLIMATE ZONE ROOF WALLS BELOW SLAB INSULATION WINDOWS DOORS MECHANICAL SYSTEM DESIGN CRITERIA MECHANICAL SYSTEM TYPE WATER HEATING SYSTEM TYPE ECONOMIZER CONTROLS FAN MOTOR DUCT SEALING DUCT AND PIPE INSULATION	*N/A*	
HEIGHT AND AREA			LIGHTING FIXTURE SCHEDULE LIGHTING WATTAGE / CONTROL NARRATIVE	*N/A* *N/A*	
	ALLOWABLE	ACTUAL	DAYLIGHT ZONES	*N/A*	
BUILDING AREA BUILDING HEIGHT	*N/A* *N/A*	*N/A* *N/A*	ROOF ASSEMBLY		
FIRE AND SMOKE RESISTANT CONSTR			CLASSIFICATION	*N/A*	
PROTECTED EXTERIOR WALLS *N/A*			ELECTRICAL		
PROTECTED EXTERIOR WALL OPENINGS ALLOWABLE WALL OPENING AREA FIRE WALLS FIRE BARRIERS FIRE PARTITIONS	DTECTED EXTERIOR WALL OPENINGS *N/A* OWABLE WALL OPENING AREA *N/A* E WALLS *N/A* E BARRIERS *N/A* E PARTITIONS *N/A*		EMERGENCY AND STANDBY POWER EXIT SIGNS MEANS OF EGRESS ILLUMINATION	REQUIRED AND PROVIDED *N/A* *N/A*	
SMOKE BARRIERS *N/A*		MECHANICAL			
INTERIOR FINISHES WALLS AND CEILINGS: EXITS	VALLS AND CEILINGS: EXITS *N/A* VALLS AND CEILINGS: EXIT ACCESS *N/A* VALLS AND CEILINGS: ROOMS *N/A* LOORS *N/A*		DUCTS AND AIR TRANSFER OPENINGS COMBUSTION AIR CHIMNEYS, FLUES, AND GAS VENTS	*N/A* *N/A* *N/A*	
WALLS AND CEILINGS: EXIT ACCESS WALLS AND CEILINGS: ROOMS FLOORS			PLUMBING		
FIRE PROTECTION SYSTEMS			FIXTURE COUNT AVAILABLE STREET WATER PRESSURE	*N/A* *N/A*	
IRE EXTINGUISHING SYSTEM *N/A*		ELEVATOR			
PORTABLE FIRE EXTINGUISHERS FIRE ALARM SYSTEM EMERGENCY VOICE	*N/A* REQUIRED AND PROVIDED REQUIRED AND PROVIDED REQUIRED AND PROVIDED *N/A*		EMERGENCY OPERATION	*N/A*	
SMOKE DETECTION SYSTEM SMOKE CONTROL			SAFEGUARDS DURING CONSTRUCTION		
SMOKEPROOF ENCLOSURE *N/A*		PEDESTRIAN PROTECTION *N/A* FIRE EXTINGUISHERS MIN. 1 PER FLOOR DURING CONSTRUCTION MEANS OF EGRESS SHALL BE MAINTAINED			
ACCESSIBILITY ROUTE TO PRIMARY FUNCTION AREAS ARE NOT REQUIRED TO BE UPGRADED TO BE ACCESSIBLE PER EBCNYS SECTION 305.7, EXCEPTION 3. NO OTHER ALTERATIONS OR WORK IMPACT ITEMS RELATED TO ACCESSIBILITY. INTERIOR ENVIRONMENT					
			FIRE SERVICE FEATURES		
			N/A FOR EXISTING BUILDING		
LIGHT	*N/A*		7		

		SYMBOL AND ABE	BREVIATIO	N LIST
	F	MANUAL PULL STATION MOUNTING HEIGHT: +48" AFF (TO CENTER), UNLESS OTHERWISE NOTED	FPC	FIRE PUMP CONTROLLER
		ENOTES ANDELA RATING	EMER	EMERGENCY GENERATOR POWER PANEL
	7 ^{75cd}	VISUAL STROBE LIGHT - WALL MOUNTED MOUNTING HEIGHT: +90" AFF (TO CENTER), UNLESS OTHERWISE NOTED XXcd = CANDELA RATING		OPTICAL FIBER NETWORK
	≥30cd	VISUAL STROBE LIGHT - CEILING MOUNTED XXcd = CANDELA RATING	FOPP	FIBER OPTIC PATCH PANEL
	√15cd C	COMBINATION SPEAKER STROBE - CEILING MOUNTED XXcd = CANDELA RATING, TAP SPEAKERS AT 1 WATT UNLESS OTHERWISE NOTED	ELEC	ELECTRICAL POWER PANEL
	15cd	COMBINATION SPEAKER STROBE - WALL MOUNTED MOUNTING HEIGHT: +90" AFF (TO CENTER), UNLESS OTHERWISE NOTED	EOL	END OF LINE RESISTOR
	Vo	XXcd = CANDELA RATING, TAP SPEAKERS AT 1 WATT UNLESS OTHERWISE NOTED	CO/NO2	CO/NO2 GAS DETECTOR
	V O F	FIRE ALARM BELL - VIBRATING	⟨S) ^W	SMOKE DETECTOR - PHOTO ELECTRIC; WALL MOUNTED
	·····································	FIRE ALARM BELL	А	ABORT STATION
	H ▼	FIRE ALARM HORN	D	MANUAL DISCHARGE PULL STATION
	S	SPEAKER ONLY - WALL MOUNTED	ZONE - X-X	ZONE IDENTIFICATION
	s c	SPEAKER ONLY - CEILING MOUNTED	PS	FIRE ALARM CONNECTION TO SPRINKLER PRESSURE SWITCH
	DH	DOOR HOLDER RELEASE		FIREFIGHTER PHONE JACK
	<u>(S)</u>	SMOKE DETECTOR - PHOTOELECTRIC; CEILING MOUNTED; W = WALL MOUNTED	(EX)	EXISTING FIRE SPRINKLER WATERFLOW/PRESSURE SWITCH, # = QUAN
	(S) E	SMOKE DETECTOR - ELEVATOR RECALL; CEILING MOUNTED	Ø(EX)	EXISTING FIRE SPRINKLER OS+Y GATE CONTROL VALVE, # = QUANTITY
		HEAT DETECTOR - 135°F FIXED TEMPERATURE UON; CEILING MOUNTED; C = CONVENTIONAL	1///	DEVICE TO BE REMOVED
	\$	DUCT SMOKE DETECTOR		OUT OF PROJECT SCOPE
	RTS	DUCT DETECTOR REMOTE TEST SWITCH W/ ALARM LED INDICATOR	EX	EXISTING
	©	CARBON MONOXIDE DETECTOR; CEILING MOUNTED; W = WALL MOUNTED	С	CONDUIT
	Р	EMERGENCY PHONE (TO REMAIN)	AHU	AIR HANDLING UNIT
	S T B	BEAM SMOKE DETECTOR - TRANSMITTER	TYP.	TYPICAL
	S R B	BEAM SMOKE DETECTOR - RECEIVER	UON	UNLESS OTHERWISE NOTED
	R #	ADDRESSABLE OUTPUT MODULE/CONTROL RELAY, # = QUANTITY	SLC	SIGNALING LINE CIRCUIT
	⟨AIM⟩#	ADDRESSABLE MONITOR MODULE, DUAL INPUT, # = QUANTITY	NAC	NOTIFICATION APPLIANCE CIRCUIT
	LED	LED TEXTUAL NOTIFICATION SIGN	IDC	INITIATING DEVICE CIRCUIT
	FATC	FIRE ALARM TERMINAL CABINET	SPK	SPEAKER CIRCUIT
	ICU	INTERCONNECTED CONTROL UNIT	STR	STAIR
	NAP	NOTIFICATION APPLIANCE REMOTE AUXILIARY POWER SUPPLIES	0	CONDUIT RISER UP
	AMP	AMPLIFIER	\cap	CONDUIT RISER DOWN
	AFSS	AUTOMATIC FIRE SUPPRESSION SYSTEM		
	SPD	SURGE PROTECTION DEVICE		
	BATT	SURGE PROTECTION DEVICE		
	RA	REMOTE ANNUNCIATOR		
	ES	LED SIGN ETHERNET SWITCH		
_	TS	PROVIDE SPRINKLER SYSTEM VALVE TAMPER SWITCH AND FIRE ALARM CONNECTION, # = QUANTITY		
	WF	FIRE ALARM CONNECTION TO SPRINKLER SYSTEM WATERFLOW SWITCH		
	LA	FIRE ALARM CONNECTION TO SPRINKLER SYSTEM LOW AIR PRESSURE SWITCH		
+	FACP	FIRE ALARM CONTROL PANEL		
	ERTC	ELEVATOR RECALL TERMINAL CABINET		
	FFTP	FIRE SERVICE TELEPHONE MASTER CONTROL PANEL		
	DOOR (EX)	EXISTING DOOR ACCESS CONTROL PANEL		



DESIGN & CONSTRUCTION

CONSULTANT

CERTIFICATE OF AUTHORIZATION #: 018416

GHD Consulting Services Inc.

WARNING:

THE ALTERATION OF THIS MATERIAL IN ANY WAY, UNLESS DONE UNDER THE DIRECTION OF A COMPARABLE PROFESSIONAL, I.E. ARCHITECT FOR AN ARCHITECT, ENGINEER FOR AN ENGINEER OR LANDSCAPE ARCHITECT FOR A LANDSCAPE ARCHITECT, IS A VIOLATION OF THE NEW YORK STATE EDUCATION LAW AND/OR REGULATIONS AND IS A CLASS 'A' MISDEMEANOR.



PROVIDE FIRE DETECTION

LOCATION: SWAN STREET BUILDING

EMPIRE STATE PLAZA

MANAGEMENT

ALBANY, NY CLIENT: OGS REAL PROPERTY


03/27/2024 ADDENDUM #1 DATE DESCRIPTION **PROJECT** 44894-E NUMBER: DESIGNED BY: DRAWN BY: FIELD CHECK:

> GENERAL NOTES, SYMBOL AND **ABBREVIATION LIST**

DRAWING NUMBER:

APPROVED:

SHEET TITLE:

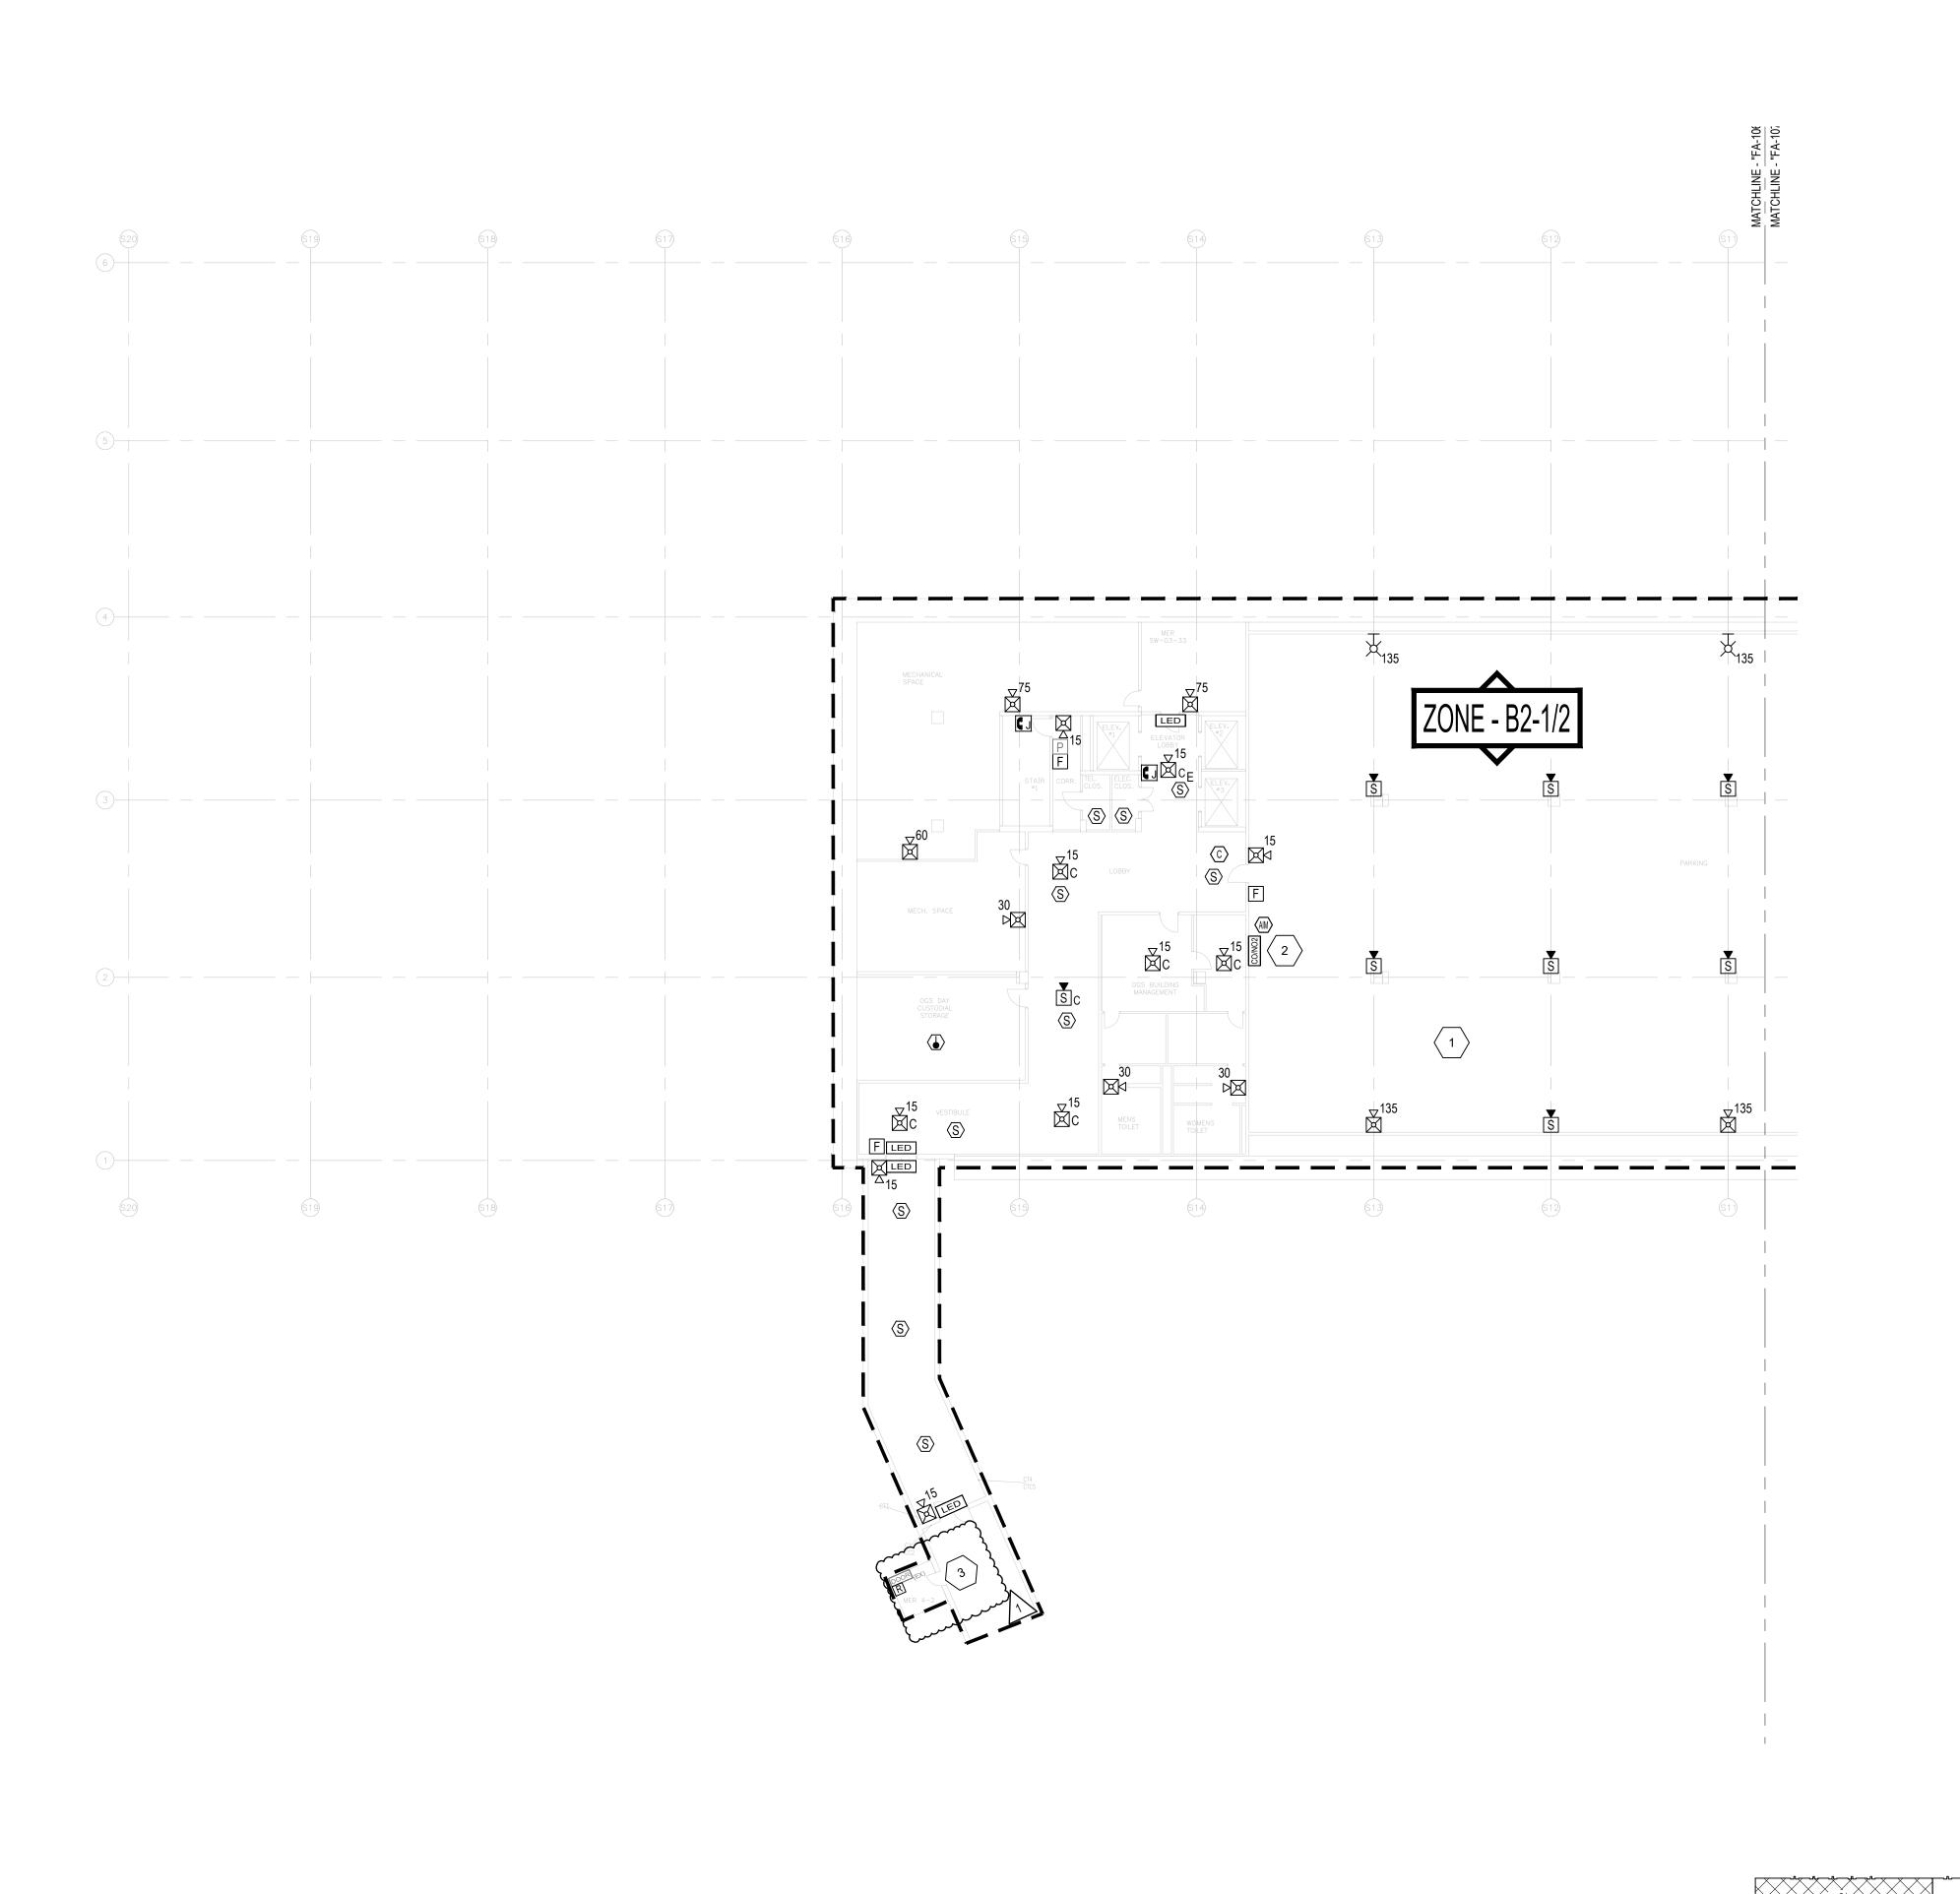

- 1. PROVIDE ALL WIRING ABOVE CEILINGS IN AREAS WITH FINISHED CEILINGS (I.E. GYP, ACT) UNLESS OTHERWISE NOTED.
- 2. PROVIDE ALL CONDUIT EXPOSED IN AREAS WITH NO FINISHED CEILINGS (I.E. MECHANICAL ROOMS, ELECTRICAL CLOSETS) UNLESS OTHERWISE NOTED.
- 3. PROVIDE ALL WIRING AND CONDUIT WITH THE REQUIRED SUPPORT/HANGERS. INSTALL ALL SUPPORTS FROM THE BUILDING STRUCTURAL STEEL.
- 4. INSTALL ALL INITIATING DEVICES IN A MANNER THAT PROVIDES ACCESSIBILITY FOR PERIODIC INSPECTION, TESTING AND MAINTENANCE.

DRAWING KEYNOTES

- PROVIDE WEATHERPROOF DEVICES IN UNCONDITIONED PARKING AREAS.
 PROVIDE MINI-ADDRESSABLE MONITOR MODULES WITHIN WEATHERPROOF NEMA 4X BACKBOXES IN UNCONDITIONED PARKING AREAS.
- 2. PROVIDE ADDRESSABLE MONITOR MODULE FOR CO/NO2 GAS DETECTOR.
- PROVIDE WIRE, CONDUIT, AND AN ADDRESSABLE RELAY OR CONTROL MODULE WITHIN 3 FEET OF THE ACCESS DOOR CONTROLLER TO RELEASE DOORS UPON ANY FIRE ALARM CONDITION FROM THE BUILDING FIRE ALARM SYSTEM. CONTRACTOR TO COORDINATE WITH THE DIRECTOR'S REPRESENTATIVE AND DOOR ACCESS CONTROL REPRESENTATIVE FOR WIRING CONNECTION REQUIREMENTS.



DESIGN & CONSTRUCTION

CONSULTANT

CERTIFICATE OF AUTHORIZATION #: 018416




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ELECTRICAL

PROVIDE FIRE DETECTION SYSTEM

SWAN STREET BUILDING

EMPIRE STATE PLAZA ALBANY, NY

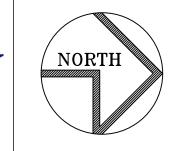/LD/ ((V), (V)

OGS REAL PROPERTY

MANAGEMENT

<u> </u>	03/27/2024	ADDENDUM #1	
MARK	DATE	DESCRIPTION	
PROJECT NUMBER:	44894-E		
DESIGNED BY:	BG/RTK		
DRAWN BY:	BG/RTK		
FIELD CHECK:			

LEVEL B2 - CORE 1
PLAN

DRAWING NUMBER:


APPROVED:

FA-106

SHEET 47 OF 82

1 LEVEL B2 - CORE 1
SCALE: 1/16" = 1'-0"

0 8' 16' 24' 32' N₆" = 1'-0 KEY PLAN

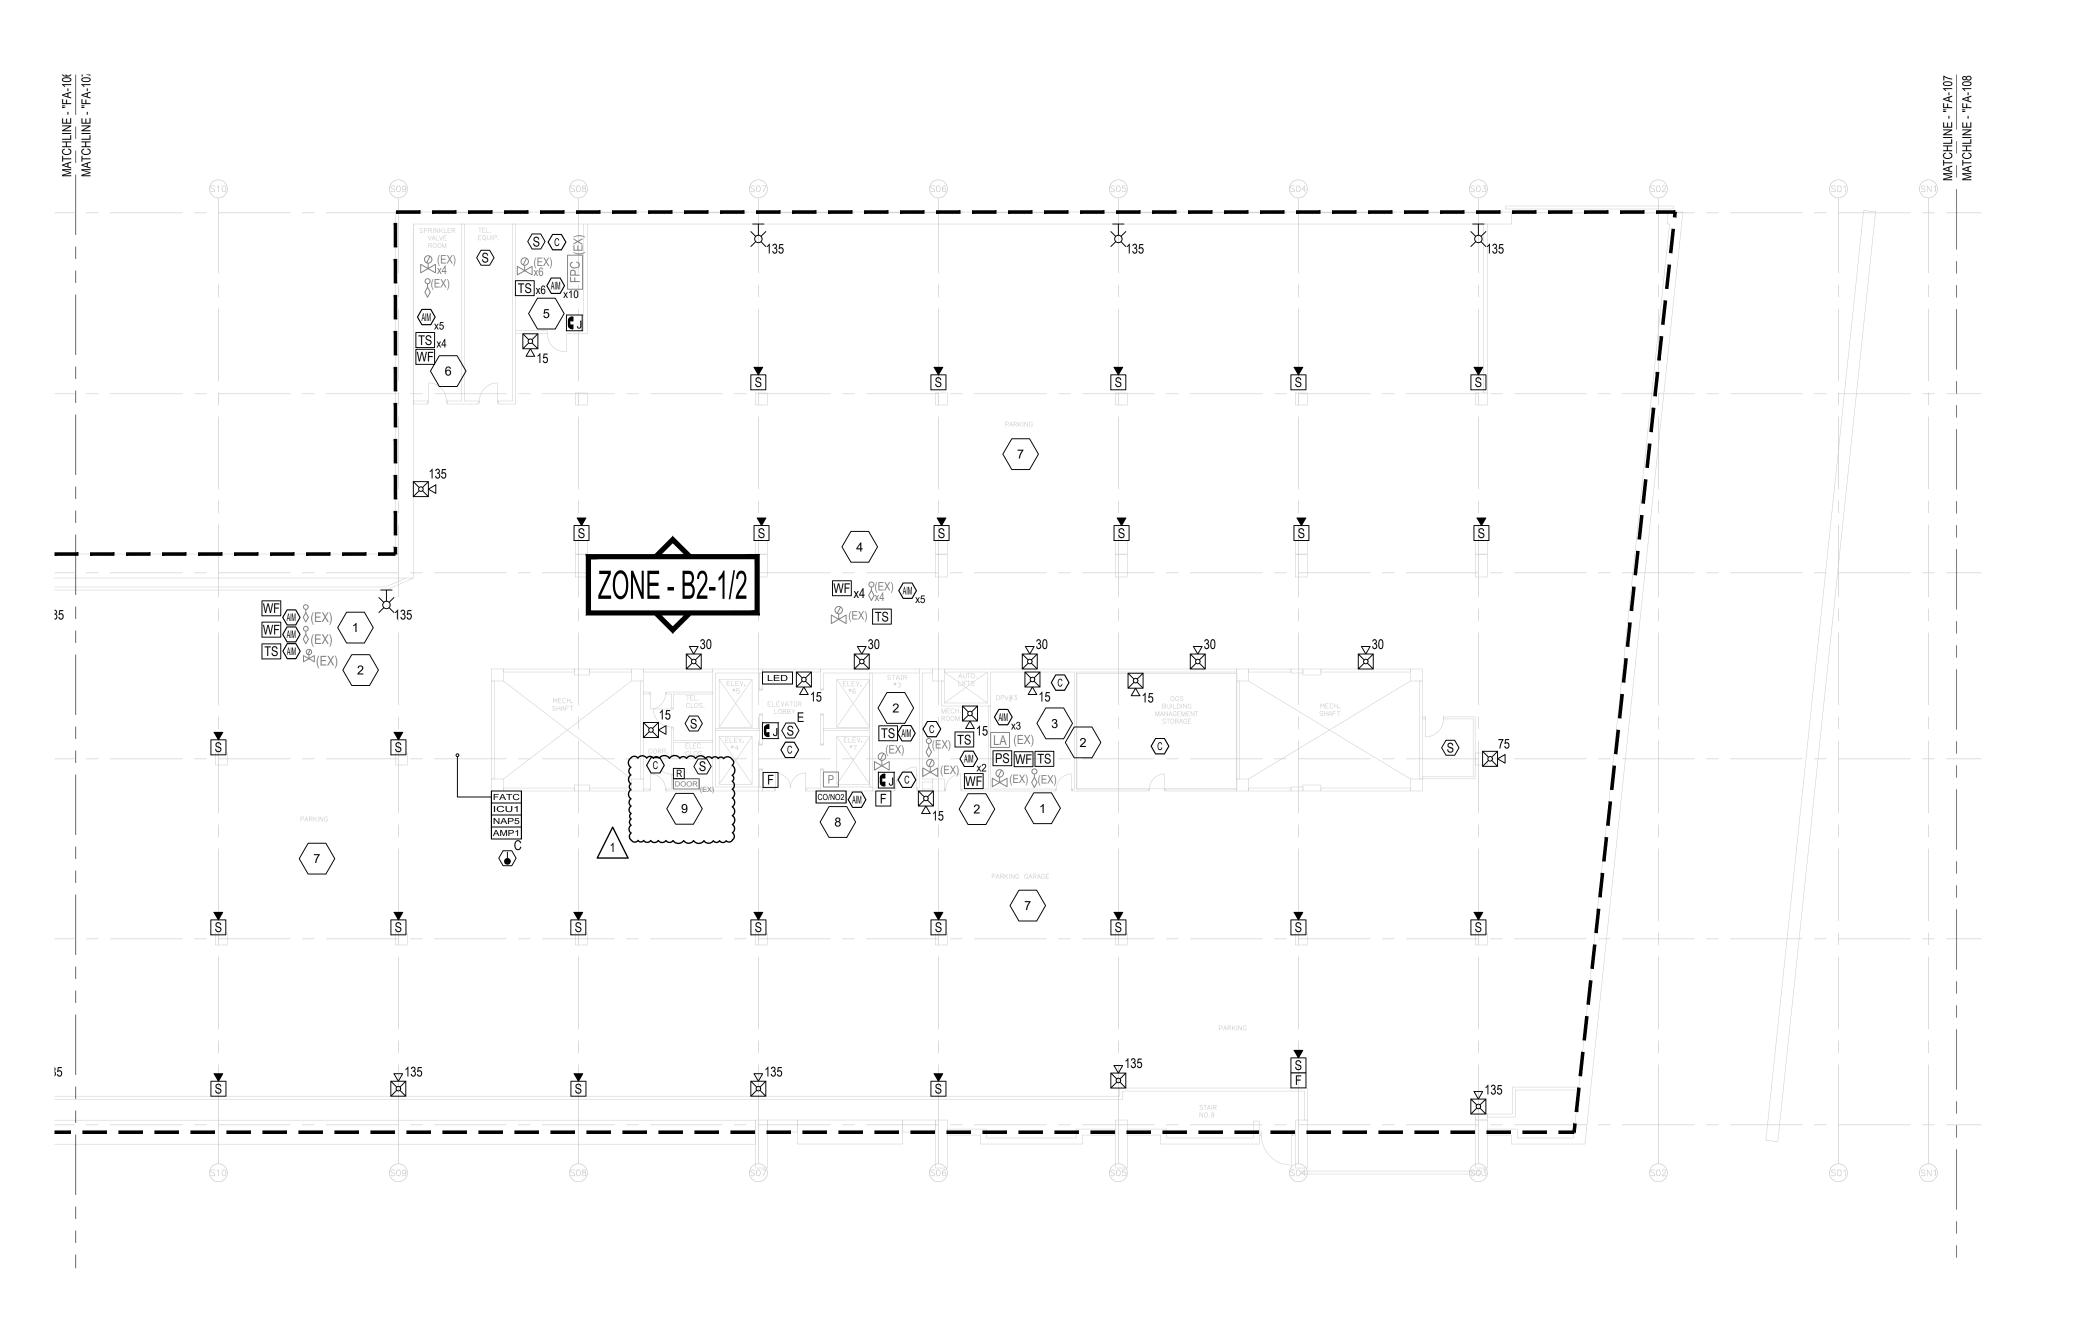

- 1. PROVIDE ALL WIRING ABOVE CEILINGS IN AREAS WITH FINISHED CEILINGS (I.E. GYP, ACT) UNLESS OTHERWISE NOTED.
- 2. PROVIDE ALL CONDUIT EXPOSED IN AREAS WITH NO FINISHED CEILINGS (I.E. MECHANICAL ROOMS, ELECTRICAL CLOSETS) UNLESS OTHERWISE NOTED.
- 3. PROVIDE ALL WIRING AND CONDUIT WITH THE REQUIRED SUPPORT/HANGERS. INSTALL ALL SUPPORTS FROM THE BUILDING STRUCTURAL STEEL.
- 4. INSTALL ALL INITIATING DEVICES IN A MANNER THAT PROVIDES ACCESSIBILITY FOR PERIODIC INSPECTION, TESTING AND MAINTENANCE.

○ DRAWING KEYNOTES

- PROVIDE ONE (1) ADDRESSABLE INPUT MODULE TO MONITOR THE EXISTING SPRINKLER SYSTEM FLOW SWITCH.
- PROVIDE TAMPER SWITCH AND ONE (1) ADDRESSABLE MONITOR MODULE TO MONITOR THE EXISTING SPRINKLER SYSTEM OS+Y CONTROL VALVE.
- PROVIDE ONE (1) ADDRESSABLE INPUT MODULE TO MONITOR THE EXISTING SPRINKLER SYSTEM LOW AIR PRESSURE SWITCH.
- PROVIDE ONE (1) TAMPER SWITCHES AND ONE (1) ADDRESSABLE INPUT MODULES FOR THE EXISTING OS+Y CONTROL VALVES, FOUR (4) ADDRESSABLE INPUT MODULES FOR THE EXISTING SPRINKLER SYSTEM WATERFLOW/PRESSURE SWITCHES.
- PROVIDE SIX (6) TAMPER SWITCHES AND SIX (6) ADDRESSABLE INPUT MODULES FOR THE EXISTING SPRINKLER SYSTEM VALVES, FOUR (4) ADDRESSABLE INPUT MODULES TO MONITOR FIRE PUMP RUN, PHASE REVERSAL, LOSS OF PHASE AND CONNECTED TO ALTERNATE SOURCE OF POWER.
- PROVIDE FOUR (4) TAMPER SWITCHES AND FOUR (4) ADDRESSABLE INPUT MODULES FOR THE EXISTING OS+Y CONTROL VALVES AND ONE (1) ADDRESSABLE INPUT MODULE FOR THE EXISTING SPRINKLER SYSTEM WATERFLOW SWITCH.
- PROVIDE WEATHERPROOF DEVICES IN UNCONDITIONED PARKING AREAS. PROVIDE MINI-ADDRESSABLE MONITOR MODULES WITHIN WEATHERPROOF NEMA 4X BACK BOXES IN UNCONDITIONED PARKING AREAS.
- PROVIDE ADDRESSABLE MONITOR MODULE FOR CO/NO2 GAS DETECTOR.
- PROVIDE WIRE, CONDUIT, AND AN ADDRESSABLE RELAY OR CONTROL MODULE WITHIN 3 FEET OF THE ACCESS DOOR CONTROLLER TO RELEASE DOORS UPON ANY FIRE ALARM CONDITION FROM THE BUILDING FIRE ALARM SYSTEM. CONTRACTOR TO COORDINATE WITH THE DIRECTOR'S REPRESENTATIVE AND DOOR ACCESS CONTROL REPRESENTATIVE FOR WIRING CONNECTION



NEW YORK OFFICE OF GENERAL Services

DESIGN & CONSTRUCTION

CONSULTANT

CERTIFICATE OF AUTHORIZATION #: 018416



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JUNE 30, 2026



ELECTRICAL

PROVIDE FIRE DETECTION

LOCATION:

SWAN STREET BUILDING EMPIRE STATE PLAZA

ALBANY, NY

OGS REAL PROPERTY MANAGEMENT

ADDENDUM #1 DATE DESCRIPTION 44894-E NUMBER: DESIGNED BY: DRAWN BY:


FIELD CHECK: APPROVED: SHEET TITLE:

LEVEL B2 - CORE 2 PLAN

DRAWING NUMBER:

FA-107

0 8' 16' 24' 32' N₆" = 1'-0 KEY PLAN

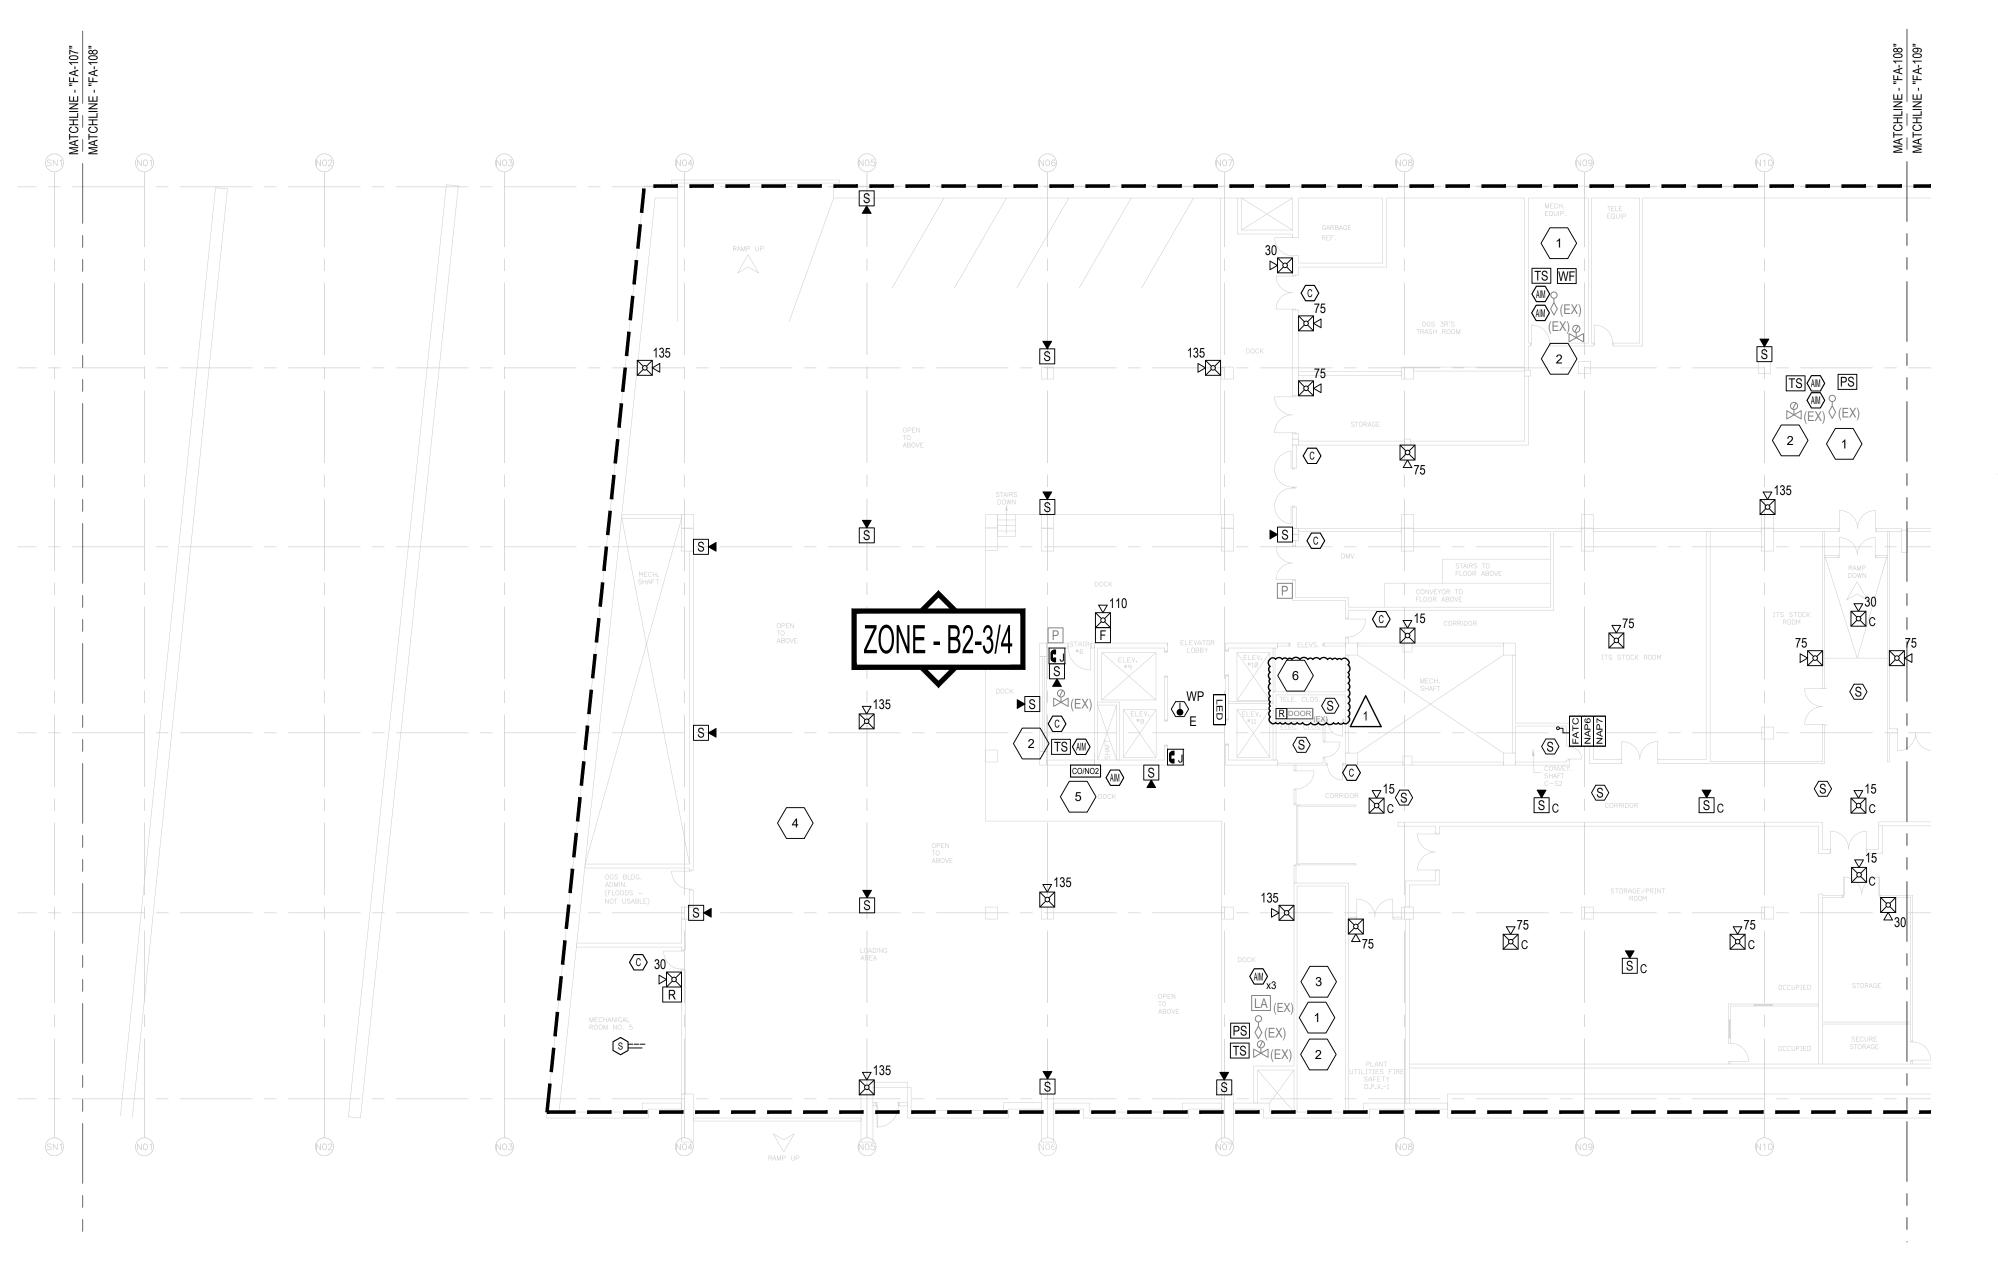

- 1. PROVIDE ALL WIRING ABOVE CEILINGS IN AREAS WITH FINISHED CEILINGS (I.E. GYP, ACT) UNLESS OTHERWISE NOTED.
- 2. PROVIDE ALL CONDUIT EXPOSED IN AREAS WITH NO FINISHED CEILINGS (I.E. MECHANICAL ROOMS, ELECTRICAL CLOSETS) UNLESS OTHERWISE NOTED.
- PROVIDE ALL WIRING AND CONDUIT WITH THE REQUIRED SUPPORT/HANGERS. INSTALL ALL SUPPORTS FROM THE BUILDING STRUCTURAL STEEL.
- 4. INSTALL ALL INITIATING DEVICES IN A MANNER THAT PROVIDES ACCESSIBILITY FOR PERIODIC INSPECTION, TESTING AND MAINTENANCE.

DRAWING KEYNOTES

- PROVIDE ONE (1) ADDRESSABLE INPUT MODULE TO MONITOR THE EXISTING SPRINKLER SYSTEM WATERFLOW PRESSURE SWITCH.
- PROVIDE TAMPER SWITCH AND ONE (1) ADDRESSABLE MONITOR MODULE TO MONITOR THE EXISTING SPRINKLER SYSTEM OS+Y CONTROL VALVE.
- PROVIDE ONE (1) ADDRESSABLE INPUT MODULE TO MONITOR THE EXISTING SPRINKLER SYSTEM LOW AIR PRESSURE SWITCH.
- PROVIDE WEATHERPROOF DEVICES IN UNCONDITIONED PARKING AREAS. PROVIDE MINI-ADDRESSABLE MONITOR MODULES WITHIN WEATHERPROOF NEMA 4X BACK BOXES IN UNCONDITIONED PARKING AREAS.
- PROVIDE ADDRESSABLE MONITOR MODULE FOR CO/NO2 GAS DETECTOR.
- PROVIDE WIRE, CONDUIT, AND AN ADDRESSABLE RELAY OR CONTROL MODULE WITHIN 3 FEET OF THE ACCESS DOOR CONTROLLER TO RELEASE DOORS UPON ANY FIRE ALARM CONDITION FROM THE BUILDING FIRE ALARM SYSTEM. CONTRACTOR TO COORDINATE WITH THE DIRECTOR'S REPRESENTATIVE AND DOOR ACCESS CONTROL REPRESENTATIVE FOR WIRING CONNECTION REQUIREMENTS.



DESIGN & CONSTRUCTION

CONSULTANT

CERTIFICATE OF AUTHORIZATION #: 018416




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LOCATION:



ELECTRICAL

PROVIDE FIRE DETECTION

SWAN STREET BUILDING

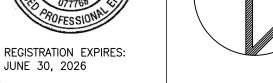EMPIRE STATE PLAZA ALBANY, NY

OGS REAL PROPERTY MANAGEMENT

ADDENDUM #1 DESCRIPTION 44894-E

DRAWN BY:

SHEET TITLE:

FA-108

1 LEVEL B2 - CORE 3
SCALE: 1/16" = 1'-0"


0 8' 16' 24' 32' 16' = 1'-0 KEY PLAN

PROJECT NUMBER: DESIGNED BY:

FIELD CHECK: APPROVED:

> LEVEL B2 - CORE 3 PLAN

DRAWING NUMBER:

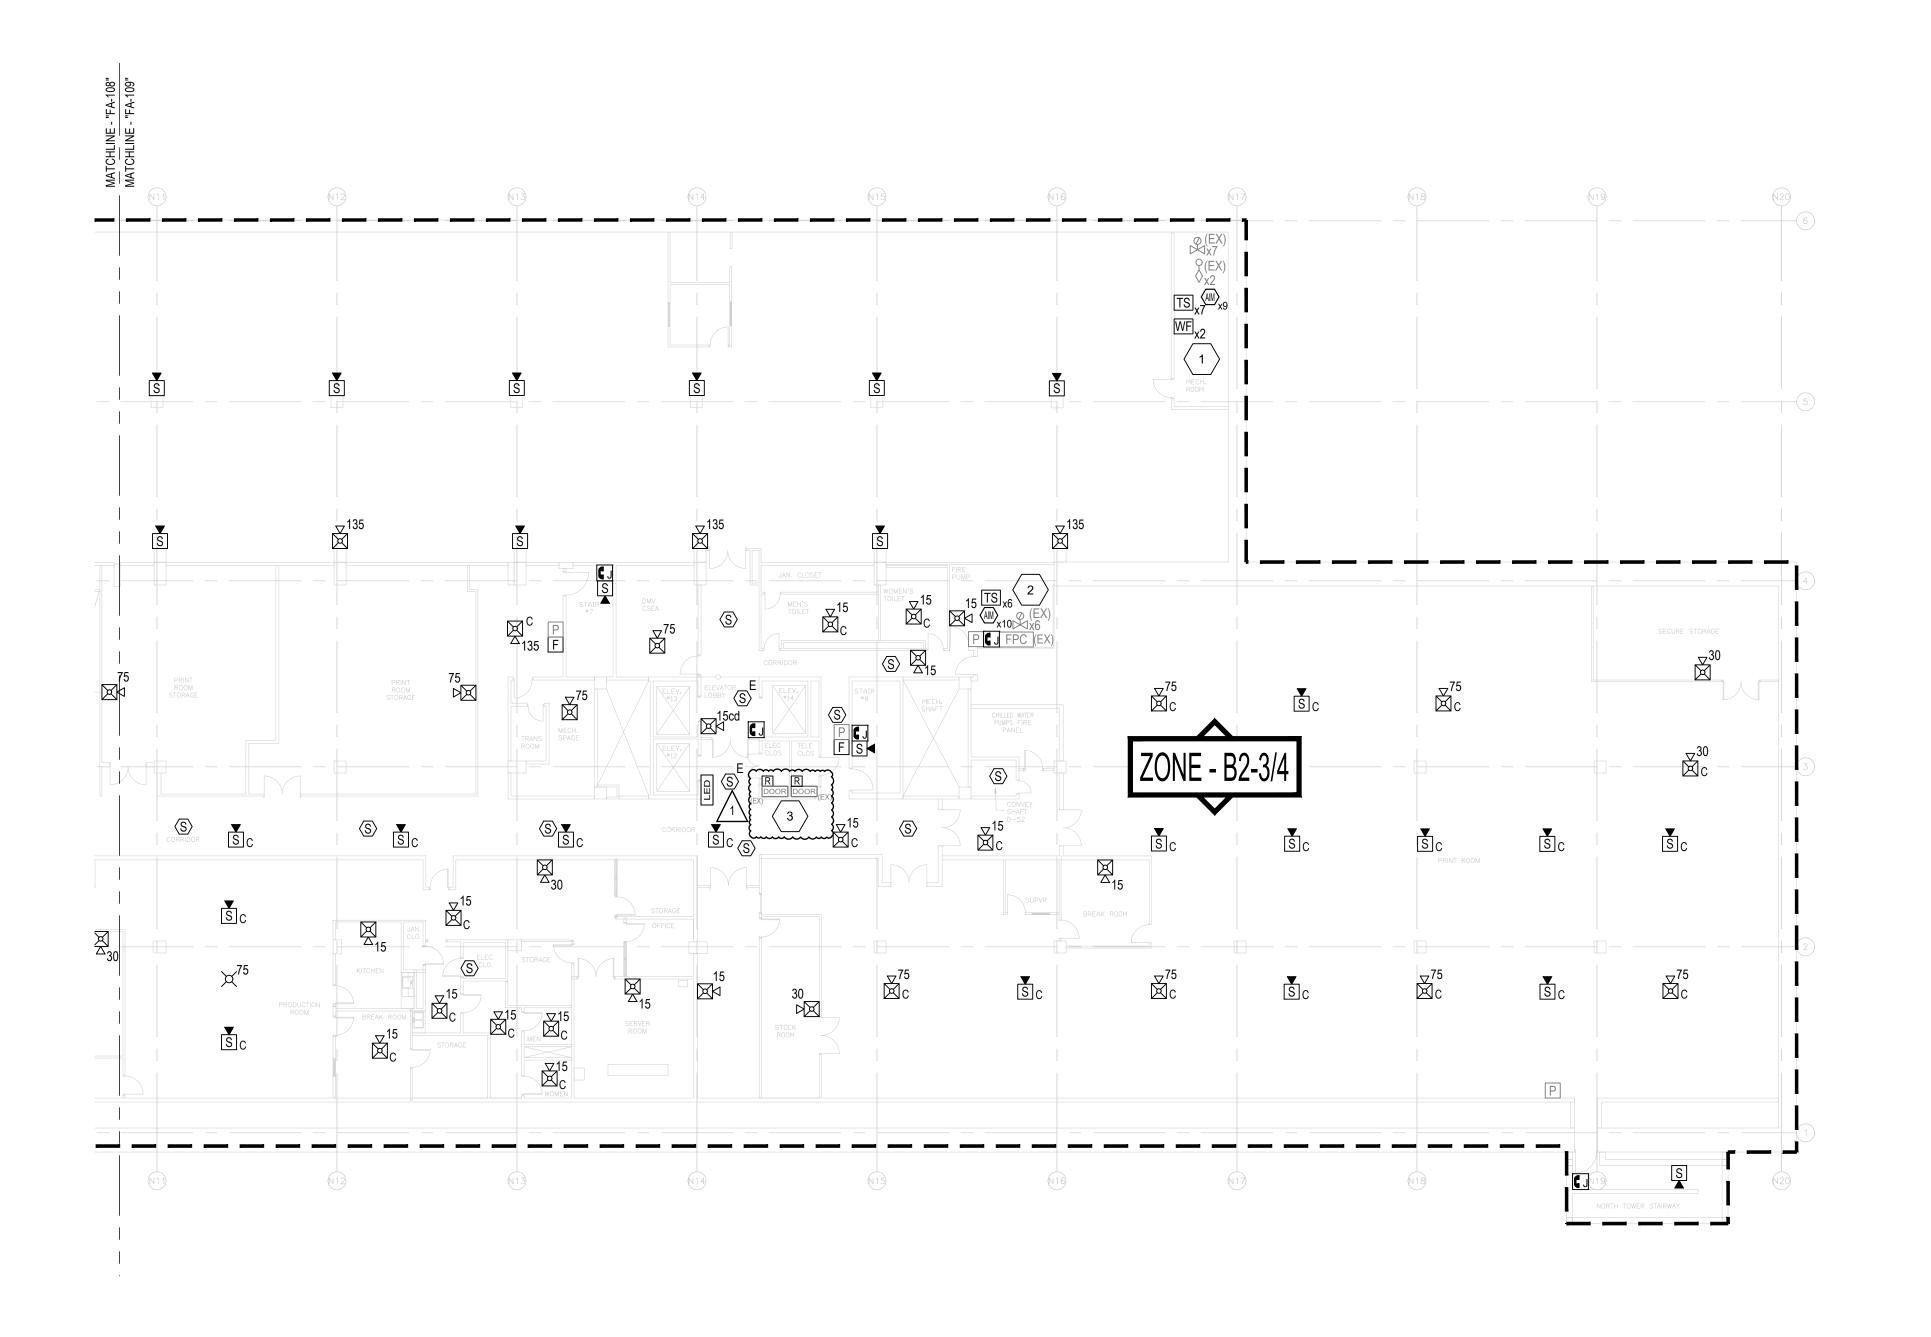

- 1. PROVIDE ALL WIRING ABOVE CEILINGS IN AREAS WITH FINISHED CEILINGS (I.E. GYP, ACT) UNLESS OTHERWISE NOTED.
- 2. PROVIDE ALL CONDUIT EXPOSED IN AREAS WITH NO FINISHED CEILINGS (I.E. MECHANICAL ROOMS, ELECTRICAL CLOSETS) UNLESS OTHERWISE NOTED.
- 3. PROVIDE ALL WIRING AND CONDUIT WITH THE REQUIRED SUPPORT/HANGERS. INSTALL ALL SUPPORTS FROM THE BUILDING STRUCTURAL STEEL.
- 4. INSTALL ALL INITIATING DEVICES IN A MANNER THAT PROVIDES ACCESSIBILITY FOR PERIODIC INSPECTION, TESTING AND MAINTENANCE.

DRAWING KEYNOTES

- PROVIDE SEVEN (7) TAMPER SWITCHES AND SEVEN (7) ADDRESSABLE INPUT MODULES TO MONITOR THE EXISTING SPRINKLER SYSTEM OS+Y CONTROL VALVE AND TWO (2) ADDRESSABLE INPUT MODULES TO MONITOR THE EXISTING SPRINKLER SYSTEM WATERFLOW/PRESSURE SWITCHES.
- 2. PROVIDE SIX (6) TAMPER SWITCHES AND SIX (6) ADDRESSABLE INPUT MODULES TO MONITOR THE EXISTING SPRINKLER SYSTEM OS+Y CONTROL VALVES AND FOUR (4) ADDRESSABLE MONITOR MODULES TO MONITOR FIRE PUMP RUN, PHASE REVERSAL, LOSS OF PHASE AND CONNECTED TO ALTERNATE SOURCE OF POWER.
- PROVIDE WIRE, CONDUIT, AND AN ADDRESSABLE RELAY OR CONTROL MODULE WITHIN 3 FEET OF THE ACCESS DOOR CONTROLLER TO RELEASE DOORS UPON ANY FIRE ALARM CONDITION FROM THE BUILDING FIRE ALARM SYSTEM. CONTRACTOR TO COORDINATE WITH THE DIRECTOR'S REPRESENTATIVE AND DOOR ACCESS CONTROL REPRESENTATIVE FOR WIRING CONNECTION REQUIREMENTS.



DESIGN & CONSTRUCTION

CONSULTANT

CERTIFICATE OF AUTHORIZATION #: 018416



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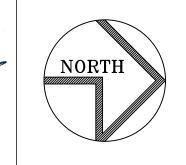
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JUNE 30, 2026

LOCATION:



ELECTRICAL

PROVIDE FIRE DETECTION

SWAN STREET BUILDING

EMPIRE STATE PLAZA ALBANY, NY

OGS REAL PROPERTY MANAGEMENT

ADDENDUM #1 DESCRIPTION 44894-E NUMBER: DESIGNED BY:

APPROVED: SHEET TITLE: LEVEL B2 - CORE 4


DRAWING NUMBER:

DRAWN BY: FIELD CHECK:

FA-109

PLAN

LEVEL B2 - CORE 4

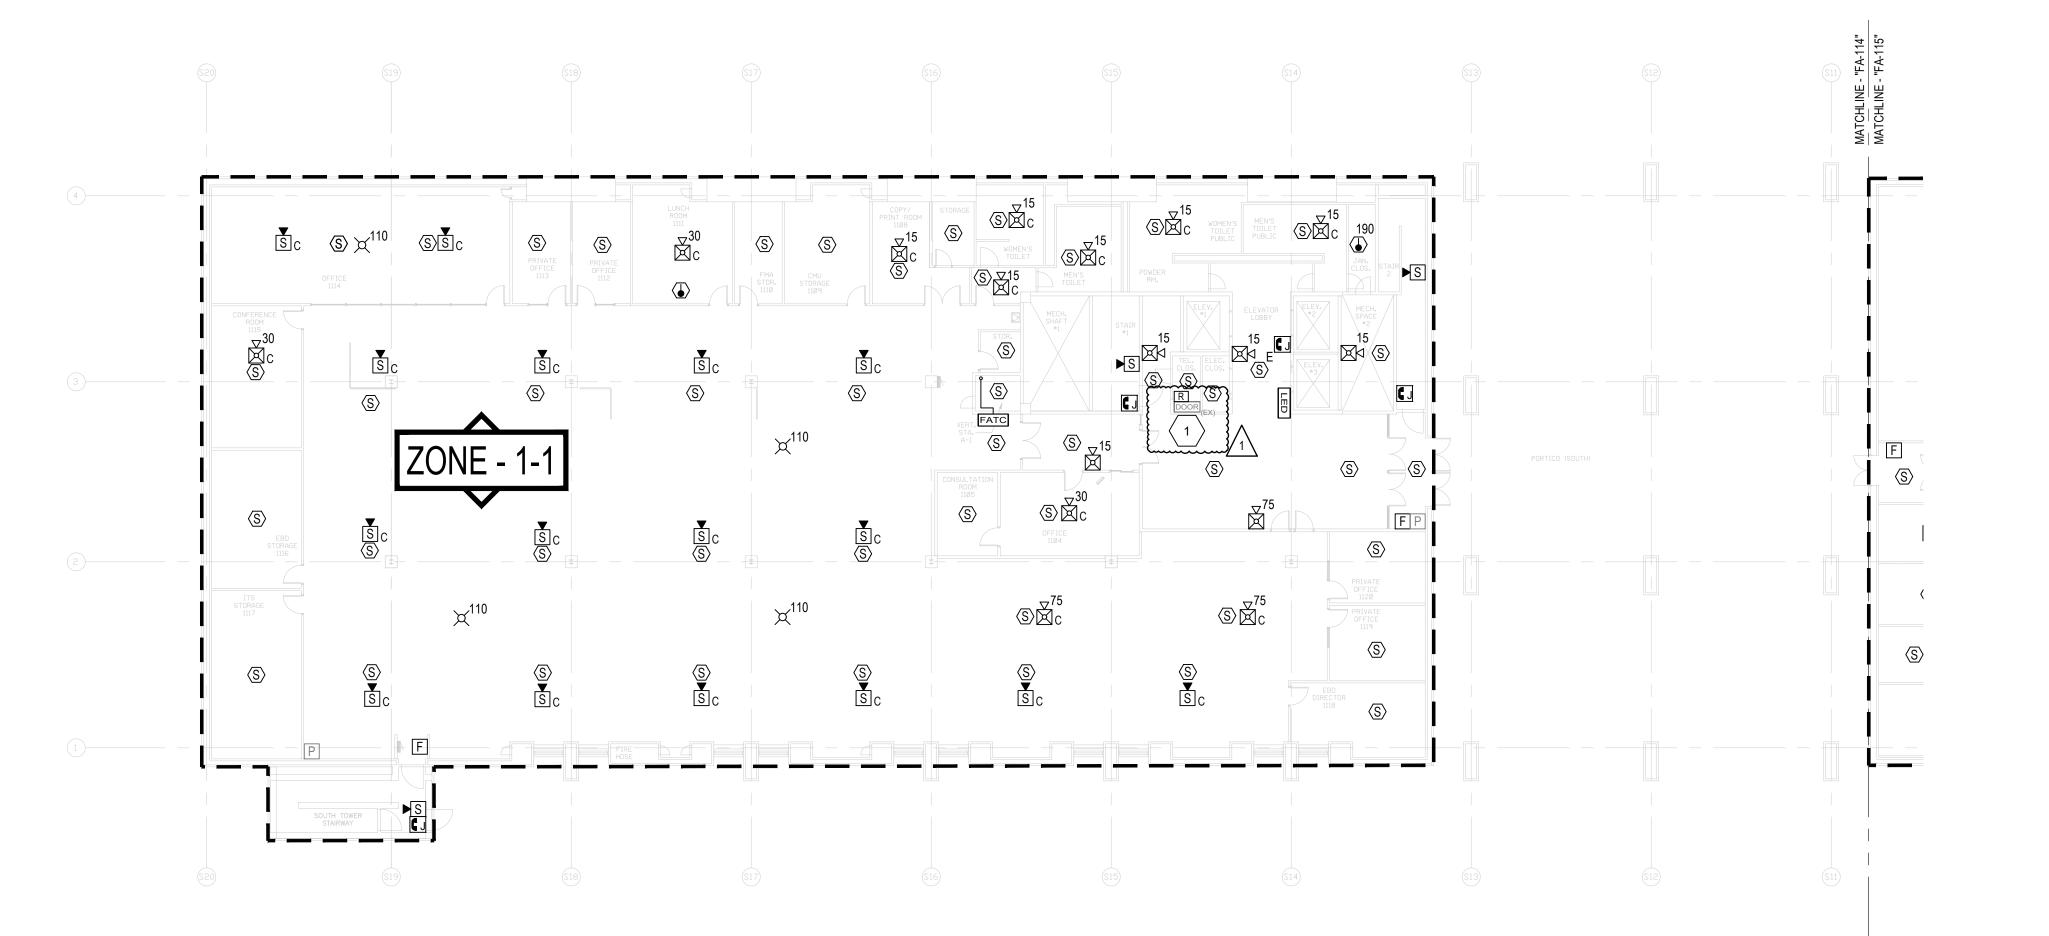

- 1. PROVIDE ALL WIRING ABOVE CEILINGS IN AREAS WITH FINISHED CEILINGS (I.E. GYP, ACT) UNLESS OTHERWISE NOTED.
- 2. PROVIDE ALL CONDUIT EXPOSED IN AREAS WITH NO FINISHED CEILINGS (I.E. MECHANICAL ROOMS, ELECTRICAL CLOSETS) UNLESS OTHERWISE NOTED.
- 3. PROVIDE ALL WIRING AND CONDUIT WITH THE REQUIRED SUPPORT/HANGERS. INSTALL ALL SUPPORTS FROM THE BUILDING STRUCTURAL STEEL.
- 4. INSTALL ALL INITIATING DEVICES IN A MANNER THAT PROVIDES ACCESSIBILITY FOR PERIODIC INSPECTION, TESTING AND MAINTENANCE.

DRAWING KEYNOTES

0 8' 16' 24' 32' 16' = 1'-0 KEY PLAN

1. PROVIDE WIRE, CONDUIT, AND AN ADDRESSABLE RELAY OR CONTROL MODULE WITHIN 3 FEET OF THE ACCESS DOOR CONTROLLER TO RELEASE DOORS UPON ANY FIRE ALARM CONDITION FROM THE BUILDING FIRE ALARM SYSTEM. CONTRACTOR TO COORDINATE WITH THE DIRECTOR'S REPRESENTATIVE AND DOOR ACCESS CONTROL REPRESENTATIVE FOR WIRING CONNECTION REQUIREMENTS.



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JUNE 30, 2026

ELECTRICAL

PROVIDE FIRE DETECTION

SWAN STREET BUILDING

EMPIRE STATE PLAZA ALBANY, NY

OGS REAL PROPERTY MANAGEMENT

ADDENDUM #1 DESCRIPTION 44894-E NUMBER:

DESIGNED BY: DRAWN BY: FIELD CHECK:


APPROVED: SHEET TITLE:

> LEVEL 1 - CORE 1 PLAN

FA-114

DRAWING NUMBER:

LEVEL 1 - CORE 1

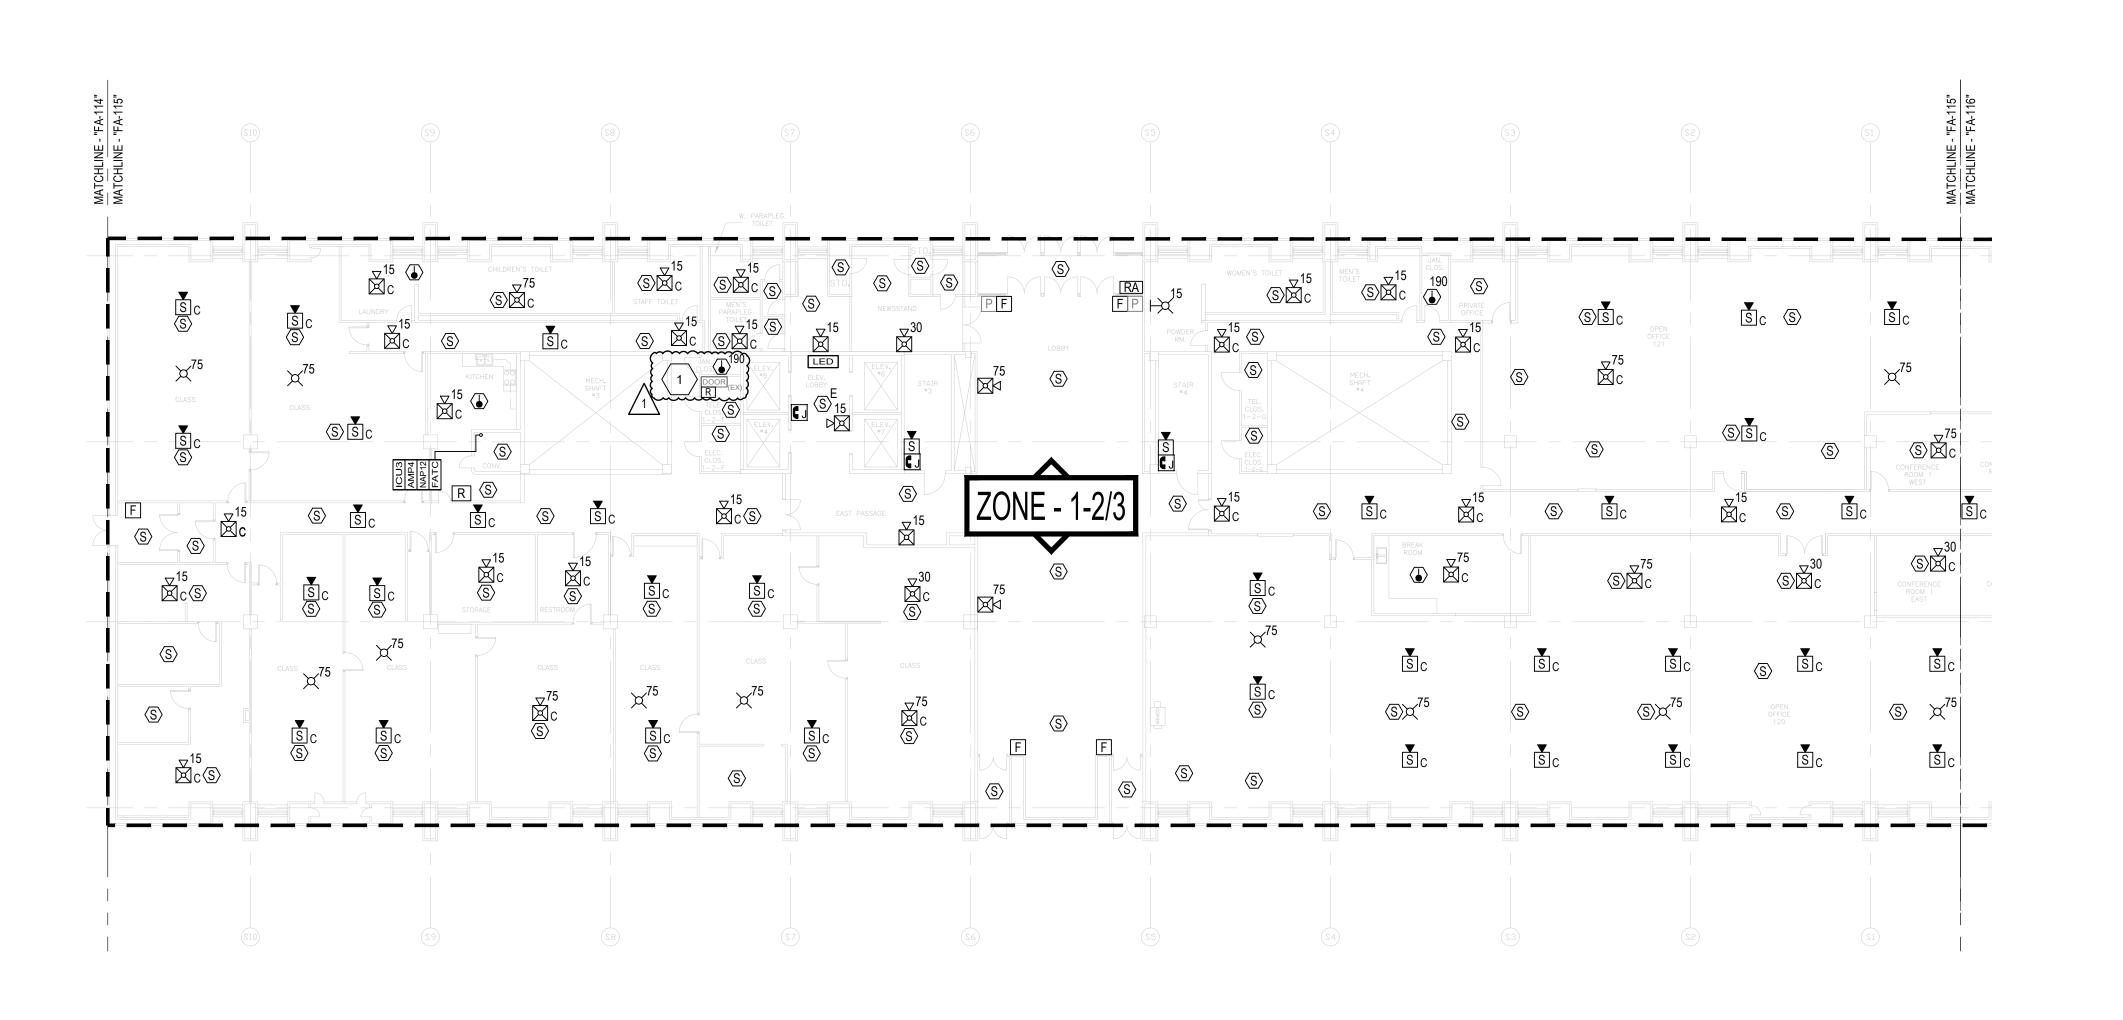

- 1. PROVIDE ALL WIRING ABOVE CEILINGS IN AREAS WITH FINISHED CEILINGS (I.E. GYP, ACT) UNLESS OTHERWISE NOTED.
- 2. PROVIDE ALL CONDUIT EXPOSED IN AREAS WITH NO FINISHED CEILINGS (I.E. MECHANICAL ROOMS, ELECTRICAL CLOSETS) UNLESS OTHERWISE NOTED.
- 3. PROVIDE ALL WIRING AND CONDUIT WITH THE REQUIRED SUPPORT/HANGERS. INSTALL ALL SUPPORTS FROM THE BUILDING STRUCTURAL STEEL.
- 4. INSTALL ALL INITIATING DEVICES IN A MANNER THAT PROVIDES ACCESSIBILITY FOR PERIODIC INSPECTION, TESTING AND MAINTENANCE.

DRAWING KEYNOTES

1. PROVIDE WIRE, CONDUIT, AND AN ADDRESSABLE RELAY OR CONTROL MODULE WITHIN 3 FEET OF THE ACCESS DOOR CONTROLLER TO RELEASE DOORS UPON ANY FIRE ALARM CONDITION FROM THE BUILDING FIRE ALARM SYSTEM. CONTRACTOR TO COORDINATE WITH THE DIRECTOR'S REPRESENTATIVE AND DOOR ACCESS CONTROL REPRESENTATIVE FOR WIRING CONNECTION REQUIREMENTS.



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NORTH

ELECTRICAL

PROVIDE FIRE DETECTION

SWAN STREET BUILDING

EMPIRE STATE PLAZA ALBANY, NY

OGS REAL PROPERTY
MANAGEMENT

O3/27/2024 ADDENDUM #1

MARK DATE DESCRIPTION

PROJECT NUMBER: 44894-E

DESIGNED BY:

DRAWN BY:

BG/RTK

FIELD CHECK:

APPROVED:

SHEET TITLE:

LEVEL 1 - CORE 2 PLAN

DRAWING NUMBER:

FA-115

SHEET 56 OF 82

1 LEVEL 1 - CORE 2

SCALE: 1/16" = 1'-0"

1 2 3 4 0 8' 16' 24' 32' N₆" = 1'-0 KEY PLAN

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DRAWING GENERAL NOTES

- PROVIDE ALL WIRING ABOVE CEILINGS IN AREAS WITH FINISHED CEILINGS (I.E. GYP, ACT) UNLESS OTHERWISE NOTED.
- PROVIDE ALL CONDUIT EXPOSED IN AREAS WITH NO FINISHED CEILINGS (I.E. MECHANICAL ROOMS, ELECTRICAL CLOSETS) UNLESS OTHERWISE NOTED.
- PROVIDE ALL WIRING AND CONDUIT WITH THE REQUIRED SUPPORT/HANGERS. INSTALL ALL SUPPORTS FROM THE BUILDING STRUCTURAL STEEL.
- INSTALL ALL INITIATING DEVICES IN A MANNER THAT PROVIDES ACCESSIBILITY FOR PERIODIC INSPECTION, TESTING AND MAINTENANCE.

DRAWING KEYNOTES

PROVIDE WIRE, CONDUIT, AND AN ADDRESSABLE RELAY OR CONTROL MODULE WITHIN 3 FEET OF THE ACCESS DOOR CONTROLLER TO RELEASE DOORS UPON ANY FIRE ALARM CONDITION FROM THE BUILDING FIRE ALARM SYSTEM. CONTRACTOR TO COORDINATE WITH THE DIRECTOR'S REPRESENTATIVE AND DOOR ACCESS CONTROL REPRESENTATIVE FOR WIRING CONNECTION REQUIREMENTS.

NEW YORK STATE OF OFFORTUNITY. Office of General Services

DESIGN & CONSTRUCTION

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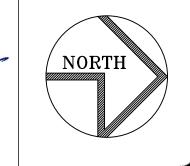
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JUNE 30, 2026

REGISTRATION EXPIRES:



ELECTRICAL

PROVIDE FIRE DETECTION

SWAN STREET BUILDING

EMPIRE STATE PLAZA ALBANY, NY

OGS REAL PROPERTY MANAGEMENT

ADDENDUM #1 DESCRIPTION 44894-E NUMBER:

DESIGNED BY: DRAWN BY: FIELD CHECK:

SHEET TITLE: LEVEL 1 - CORE 3 PLAN

APPROVED:

FA-116

DRAWING NUMBER:

LEVEL 1 - CORE 3

- 1. PROVIDE ALL WIRING ABOVE CEILINGS IN AREAS WITH FINISHED CEILINGS (I.E. GYP, ACT) UNLESS OTHERWISE NOTED.
- 2. PROVIDE ALL CONDUIT EXPOSED IN AREAS WITH NO FINISHED CEILINGS (I.E. MECHANICAL ROOMS, ELECTRICAL CLOSETS) UNLESS OTHERWISE NOTED.
- 3. PROVIDE ALL WIRING AND CONDUIT WITH THE REQUIRED SUPPORT/HANGERS. INSTALL ALL SUPPORTS FROM THE BUILDING STRUCTURAL STEEL.
- 4. INSTALL ALL INITIATING DEVICES IN A MANNER THAT PROVIDES ACCESSIBILITY FOR PERIODIC INSPECTION, TESTING AND MAINTENANCE.

DRAWING KEYNOTES

- 1. PROVIDE FIBEROPTIC NETWORK CABLE ROUTED FROM FACP TO EXISTING FIBEROPTIC PATCH PANEL LOCATED IN ICM-18 LOCATED ON LEVEL B3, CORE 3.
 - PROVIDE WIRE, CONDUIT, AND AN ADDRESSABLE RELAY OR CONTROL MODULE WITHIN 3 FEET OF THE ACCESS DOOR CONTROLLER TO RELEASE DOORS UPON ANY FIRE ALARM CONDITION FROM THE BUILDING FIRE ALARM SYSTEM. CONTRACTOR TO COORDINATE WITH THE DIRECTOR'S REPRESENTATIVE AND DOOR ACCESS CONTROL REPRESENTATIVE FOR WIRING CONNECTION REQUIREMENTS.



DESIGN & CONSTRUCTION

CONSULTANT

CERTIFICATE OF AUTHORIZATION #: 018416



GHD Consulting Services Inc.


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JUNE 30, 2026





ELECTRICAL

PROVIDE FIRE DETECTION SYSTEM

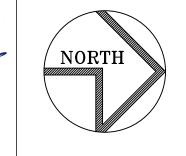SWAN STREET BUILDING

EMPIRE STATE PLAZA ALBANY, NY

OGS REAL PROPERTY MANAGEMENT

ADDENDUM #1 DESCRIPTION PROJECT NUMBER: 44894-E


DESIGNED BY: DRAWN BY: FIELD CHECK: APPROVED:

SHEET TITLE: LEVEL 1 - CORE 4 PLAN

DRAWING NUMBER:

FA-117

LEVEL 1 - CORE 4

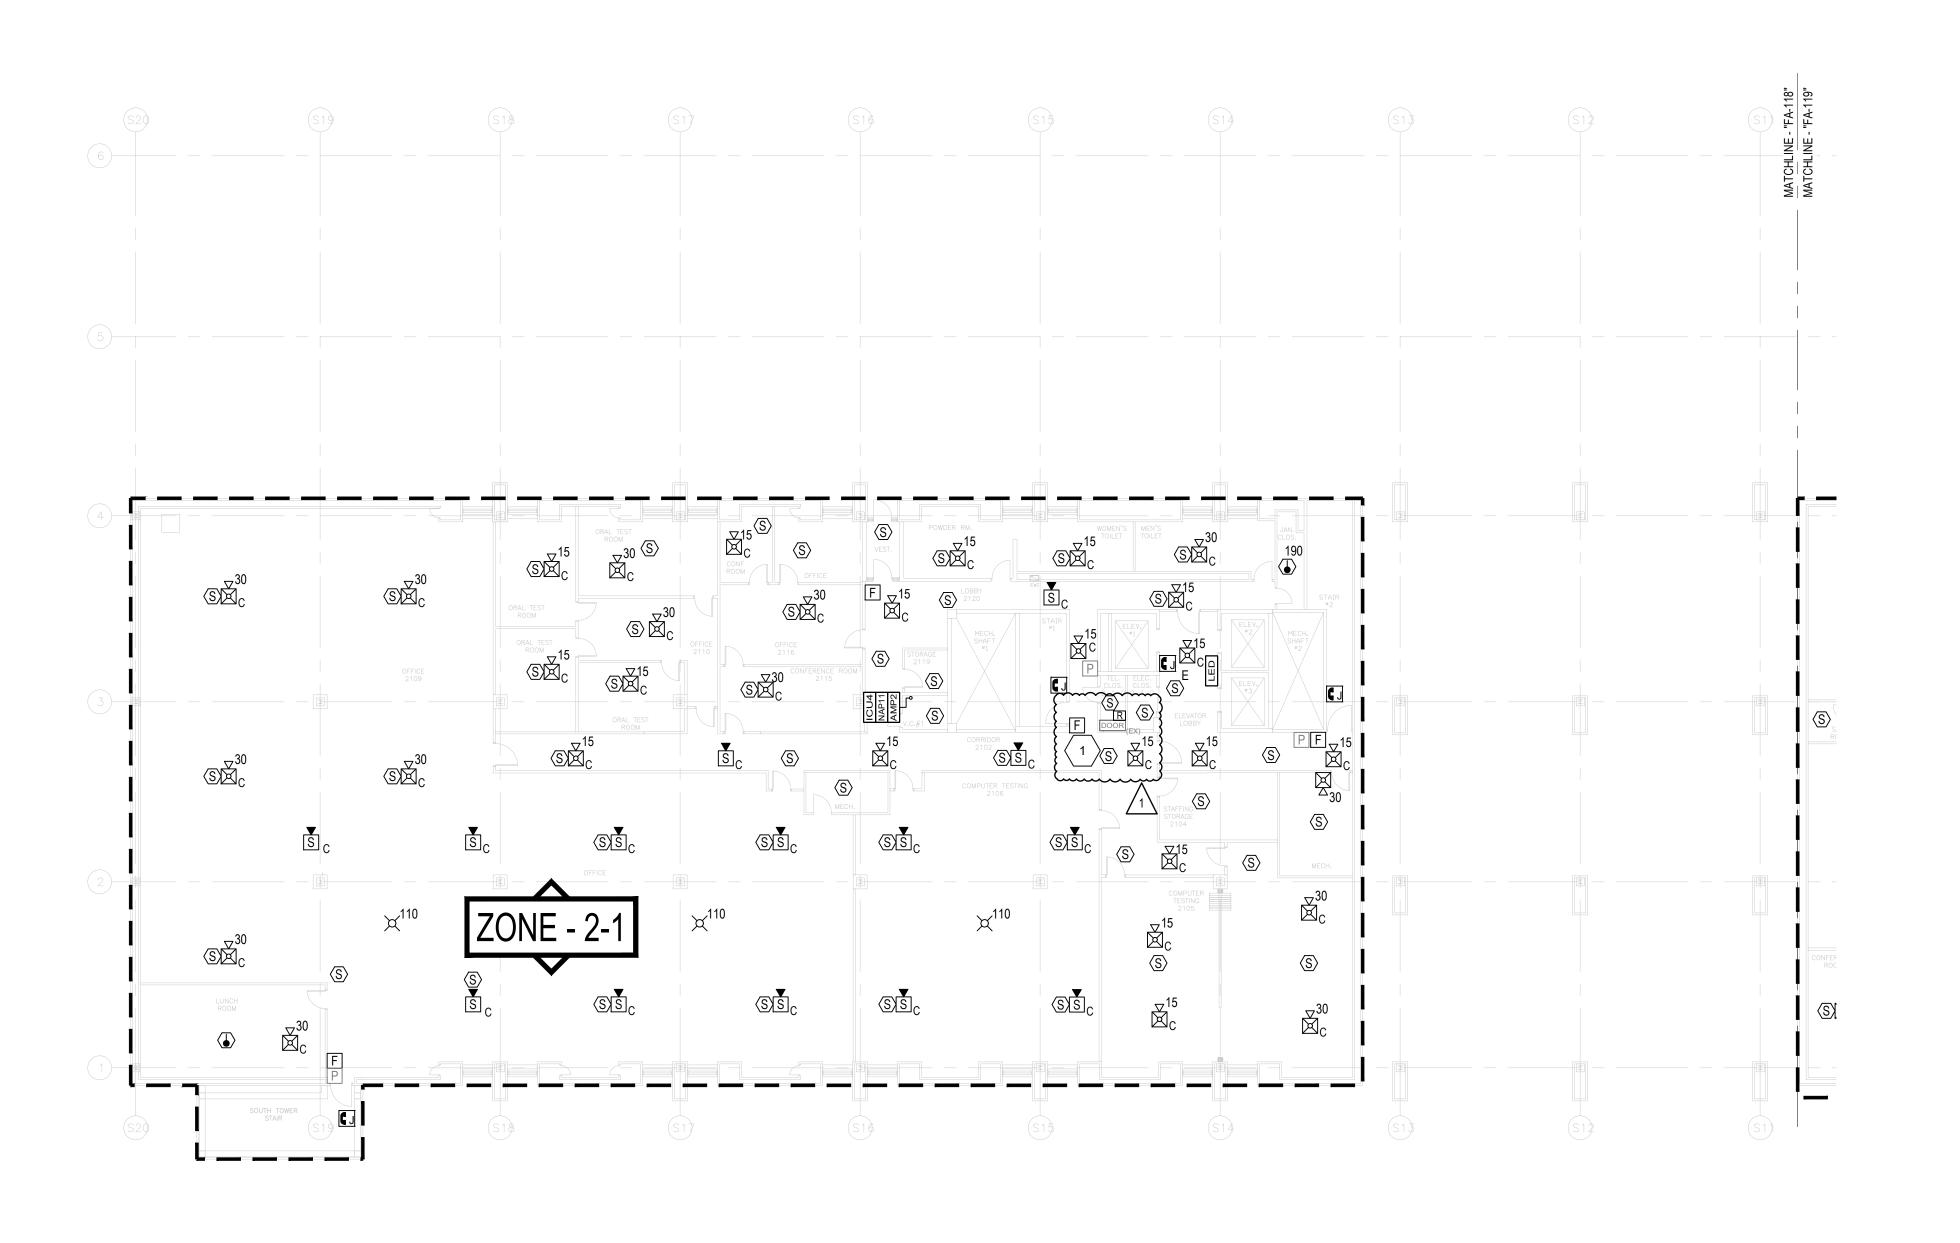

- 1. PROVIDE ALL WIRING ABOVE CEILINGS IN AREAS WITH FINISHED CEILINGS (I.E. GYP, ACT) UNLESS OTHERWISE NOTED.
- 2. PROVIDE ALL CONDUIT EXPOSED IN AREAS WITH NO FINISHED CEILINGS (I.E. MECHANICAL ROOMS, ELECTRICAL CLOSETS) UNLESS OTHERWISE NOTED.
- PROVIDE ALL WIRING AND CONDUIT WITH THE REQUIRED SUPPORT/HANGERS. INSTALL ALL SUPPORTS FROM THE BUILDING STRUCTURAL STEEL.
- 4. INSTALL ALL INITIATING DEVICES IN A MANNER THAT PROVIDES ACCESSIBILITY FOR PERIODIC INSPECTION, TESTING AND MAINTENANCE.

DRAWING KEYNOTES

PROVIDE WIRE, CONDUIT, AND AN ADDRESSABLE RELAY OR CONTROL MODULE WITHIN 3 FEET OF THE ACCESS DOOR CONTROLLER TO RELEASE DOORS UPON ANY FIRE ALARM CONDITION FROM THE BUILDING FIRE ALARM SYSTEM. CONTRACTOR TO COORDINATE WITH THE DIRECTOR'S REPRESENTATIVE AND DOOR ACCESS CONTROL REPRESENTATIVE FOR WIRING CONNECTION REQUIREMENTS.

NEW YORK OFFICE OF GENERAL Services

DESIGN & CONSTRUCTION

CONSULTANT

CERTIFICATE OF AUTHORIZATION #: 018416




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ELECTRICAL

PROVIDE FIRE DETECTION

SWAN STREET BUILDING

EMPIRE STATE PLAZA ALBANY, NY

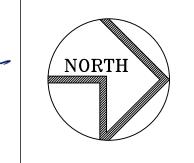OGS REAL PROPERTY MANAGEMENT


ADDENDUM #1 DESCRIPTION 44894-E NUMBER: DESIGNED BY: DRAWN BY:

FIELD CHECK: APPROVED: SHEET TITLE:

> LEVEL 2 - CORE 1 PLAN

DRAWING NUMBER:

FA-118

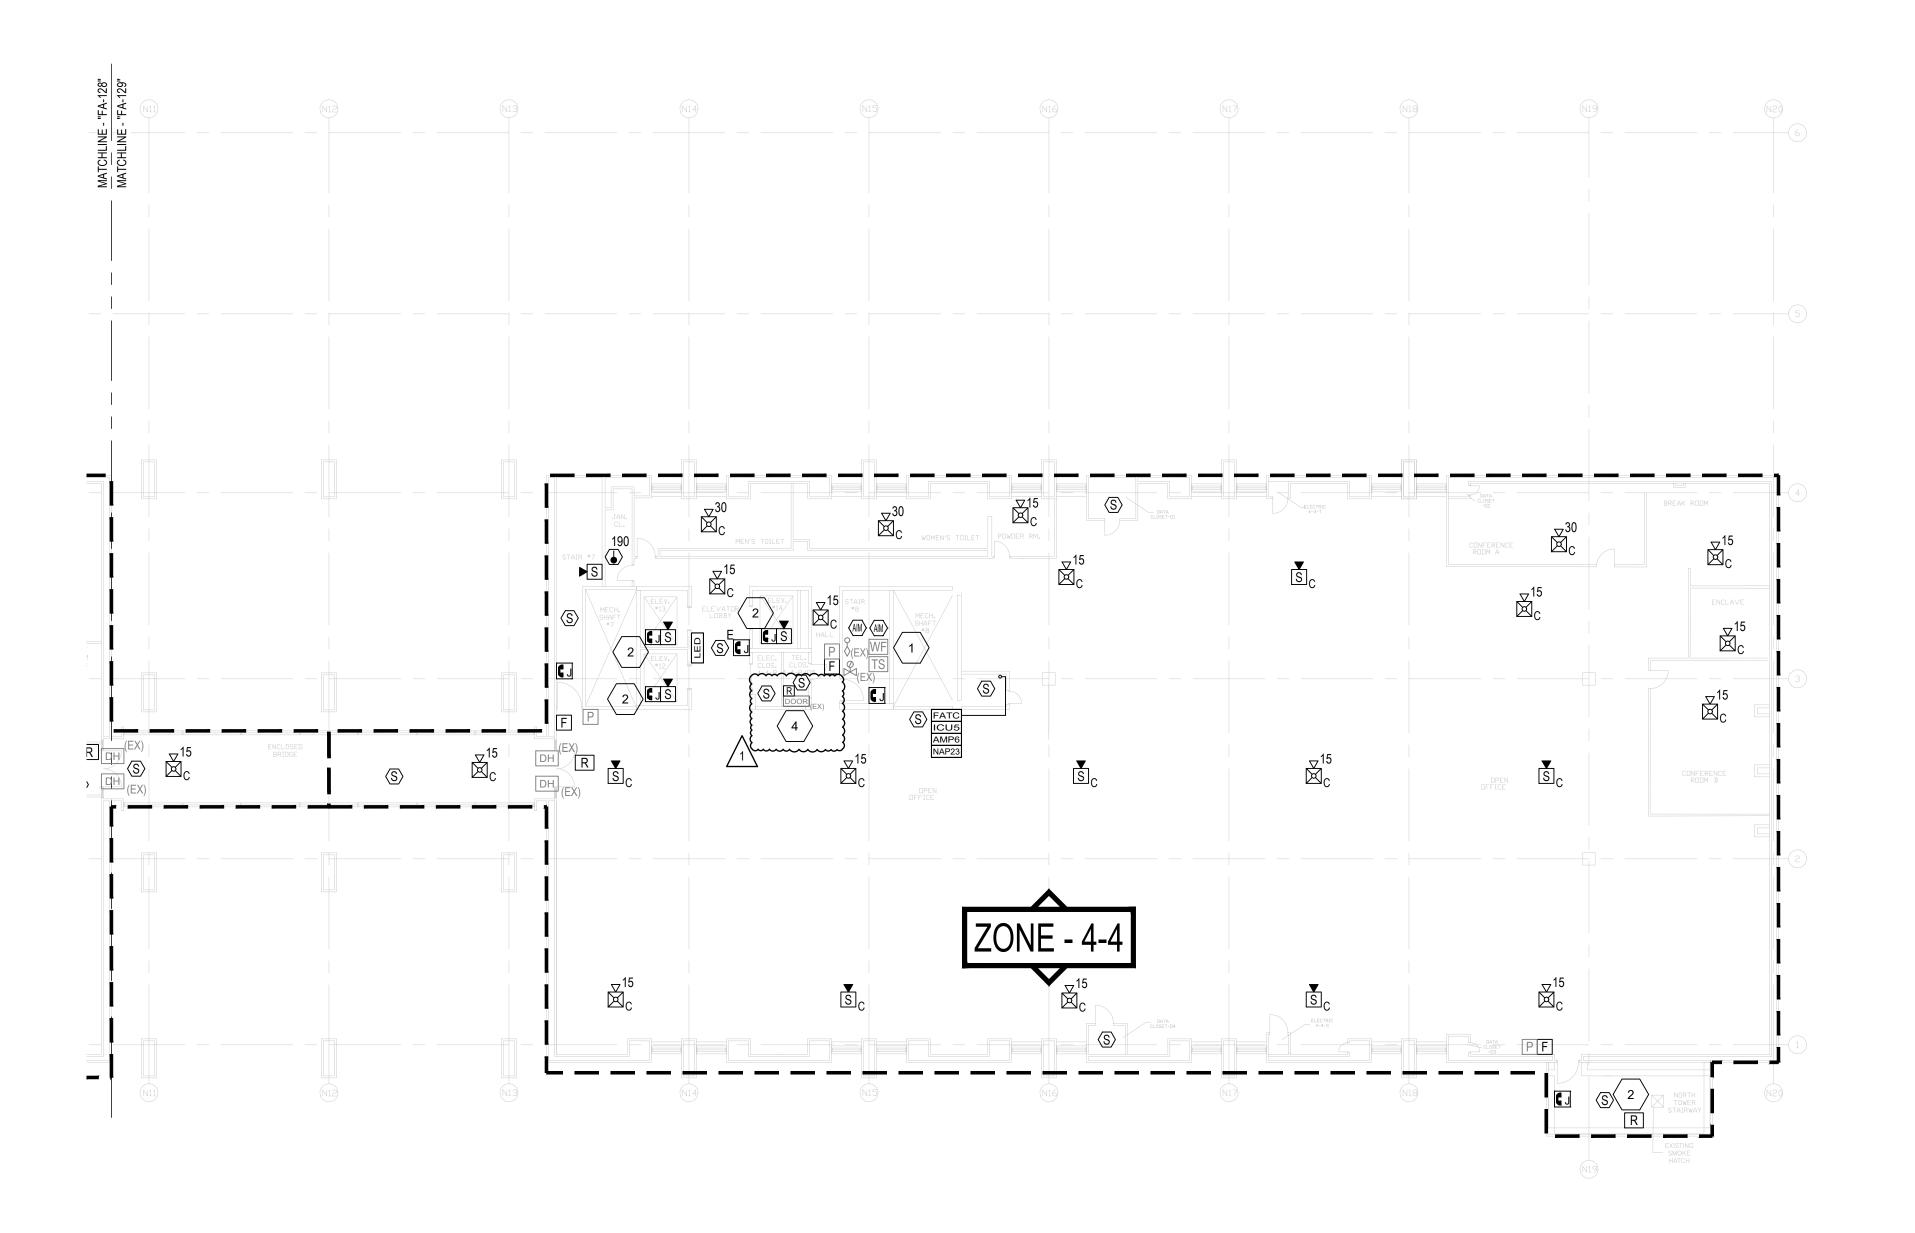

- 1. PROVIDE ALL WIRING ABOVE CEILINGS IN AREAS WITH FINISHED CEILINGS (I.E. GYP, ACT) UNLESS OTHERWISE NOTED.
- PROVIDE ALL CONDUIT EXPOSED IN AREAS WITH NO FINISHED CEILINGS (I.E. MECHANICAL ROOMS, ELECTRICAL CLOSETS) UNLESS OTHERWISE NOTED.
- 3. PROVIDE ALL WIRING AND CONDUIT WITH THE REQUIRED SUPPORT/HANGERS. INSTALL ALL SUPPORTS FROM THE BUILDING STRUCTURAL STEEL.
- 4. INSTALL ALL INITIATING DEVICES IN A MANNER THAT PROVIDES ACCESSIBILITY FOR PERIODIC INSPECTION, TESTING AND MAINTENANCE.

> DRAWING KEYNOTES

- PROVIDE ADDRESSABLE INPUT MODULES FOR EXISTING SPRINKLER SYSTEM WATERFLOW SWITCH AND CONTROL VALVE TAMPER SWITCH.
- 2. PROVIDE SPEAKER AND FIREFIGHTER PHONE JACK IN ELEVATOR.
- SMOKE DETECTOR SHALL BE CIRCUITED TO OPEN THE TOP OF STAIR SMOKE HATCH UPON ACTIVATION. PROVIDE RELAY. REMOVE EXISTING 120VAC ACTUATOR AND PROVIDE 24VDC ACTUATOR.
- 4. PROVIDE WIRE, CONDUIT, AND AN ADDRESSABLE RELAY OR CONTROL MODULE WITHIN 3 FEET OF THE ACCESS DOOR CONTROLLER TO RELEASE DOORS UPON ANY FIRE ALARM CONDITION FROM THE BUILDING FIRE ALARM SYSTEM. CONTRACTOR TO COORDINATE WITH THE DIRECTOR'S REPRESENTATIVE AND DOOR ACCESS CONTROL REPRESENTATIVE FOR WIRING CONNECTION REQUIREMENTS.



DESIGN & CONSTRUCTION

CONSULTANT

CERTIFICATE OF AUTHORIZATION #: 018416



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JUNE 30, 2026



ELECTRICAL

PROVIDE FIRE DETECTION

N: SWAN STREET BUILDING EMPIRE STATE PLAZA

ALBANY, NY

OGS REAL PROPERTY MANAGEMENT

03/27/2024 ADDENDUM #1

MARK DATE DESCRIPTION

PROJECT NUMBER: 44894-E

DESIGNED BY: BG/RTK

DRAWN BY: BG/RTK

APPROVED:
SHEET TITLE:

LEVEL 4 - CORE 4 PLAN

DRAWING NUMBER:

FIELD CHECK:

FA-129

SHEET 70 OF 82

1 LEVEL 4 - CORE 4

SCALE: 1/16" = 1'-0"